

22-243

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DATE	Septembe	er 15, 2022		C	.D	13
BOARD O	F RECRE	ATION AND PARK	COMMISS	SIONERS		
SUBJECT		ADVISORY AGEN		TT) NO. 82118 - RECO AND DEDICATION OR		
AP Diaz H. Fujita B. Jackson		M. Rudnick C. Santo Domingo N. Williams	DF	General	Manager	
Approved	Х	Dis	sapproved		Vithdrawn	

#### **RECOMMENDATIONS**

- Recommend that the Advisory Agency require Vesting Tentative Tract (VTT) 82118 (Project) to pay in-lieu fees to the City in order to fulfill the Project's requirements under provisions of Los Angeles Municipal Code (LAMC) Section 12.33; and,
- 2. Authorize the Department of Recreation and Parks' (RAP) General Manager or designee to provide a Report to the Advisory Agency informing them of the Board of Recreation and Park Commissioners' (Board) recommendation.

#### **SUMMARY**

Ordinance 184,505 (Parks Dedication and Fee Update Ordinance) became effective on January 11, 2017. Ordinance 184,505 requires most residential projects that create new dwelling units or joint living and work quarters to dedicate land or to pay a fee in-lieu (Park Fee) for the purpose of developing park and recreational facilities. Residential projects that propose one or more additional dwelling units are subject to these requirements unless they meet one of the exceptions listed in LAMC Section 12.33 C.3 (e.g. certain affordable housing units and secondary dwelling units may be exempt from any requirement to pay a fee).

LAMC Section 17.03 (Advisory Agency) states in part that, "[t]he Advisory Agency is charged with the duty of making investigations and reports on the design and improvement of proposed subdivisions, of requiring the dedication of land, the payment of fees in lieu thereof, or a combination of both, for the acquisition and development of park and recreation sites and facilities...". The Director of the City Planning Department (City Planning) is designated as the Advisory Agency for the City of Los Angeles and is authorized to act in such capacity through one or more deputies appointed by him or her for that purpose.

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LAMC Section 17.04 (Subdivision Committee) states that RAP is to submit a Report to the Advisory Agency for each application for subdivision map approval and that report "shall contain recommendations, approved by the Board of Recreation and Park Commissioners, specifying the land to be dedicated, the payment of fees in lieu thereof, or a combination of both for the acquisition and development of park or recreational sites and facilities to serve the future inhabitants of such subdivision... ".

#### PROJECT SUMMARY

The Project is located at 5645 West Fernwood Avenue in the Hollywood community of the City. The Project site is approximately 0.63 gross acres. The Project, as currently proposed, includes the construction of a 26-story, 499-unit Senior Independent Living apartment building, of which 494 units will be restricted as affordable with 5 manager's units.

The Project also includes approximately 25,125 square feet of common open space, including an outdoor terrace on level 26, a public plaza, patio space, lobbies, a community center, business center, social services center, library, fitness center and outdoor walking paths.

The Project, as submitted to City Planning, is not proposing to make a land dedication to the City of Los Angeles either on-site or off-site of the project location.

Conceptual renderings of the Project are attached (Attachment 1).

#### **EARLY CONSULTATION MEETING**

Pursuant to LAMC Section 12.33 D.1, applicants of residential Subdivision projects with more than fifty (50) residential dwelling units are required to meet with RAP and City Planning prior to submitting a tract map application to City Planning. Per LAMC Section 12.33 D.1, "[t]he purpose of this early consultation is to discuss whether the City requires land dedication for the project and/or to discuss credits available to the applicant, if any."

RAP and City Planning staff held an Early Consultation meeting with Project representatives on <u>May 2, 2022</u>. The meeting included a discussion of the requirements of Los Angeles Municipal Code Section 12.33, the maximum land dedication that the Project could be required to provide, options and opportunities for on-site or off-site park land dedications, the calculation of Park Fees, and the various recreational credits available to the Project.

#### ADVISORY AGENCY

The Project filed a tract map application with City Planning on <u>July 7, 2022</u>. On August 4, 2022, the Advisory Agency sent RAP a notification requesting RAP provide its report and recommendations on the Project by September 13, 2022. The Advisory Agency Filing Notification is attached (Attachment 2).

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If no written Report is provided to the Advisory Agency, the Advisory Agency will assume that RAP has no report to make.

#### REQUIRED LAND DEDICATION / IN-LIEU FEE PAYMENT

Pursuant to LAMC Section 12.33 C, "All new residential dwelling units and joint living and work quarters shall be required to dedicate land, pay a fee, or provide a combination of land dedication and fee payment for the purpose of acquiring, expanding and improving park and recreational facilities for new residents."

#### Land Dedication

LAMC Section 12.33 D states that residential Subdivision projects with more than fifty (50) residential dwelling units can be required by the City to dedicate land to the City for park and recreation purposes. The maximum amount of land that the Advisory Agency could require a project to dedicate to the City is calculated based on the formula detailed in LAMC Section 12.33 D.2:

- LD = (DU x P) x F
  - LD = Land to be dedicated in acres.
  - DU = Total number of new market-rate dwelling units.
  - P = Average number of people per occupied dwelling unit as determined by the most recent version of the U.S. Census for the City of Los Angeles.
    - P = 2.88
  - F = Park Service factor, as indicated by the Department of Recreation and Parks rate and fee schedule.
    - F = 0.00251 (2.51 acres of park land per 1,000 residents)

The **maximum** land dedication for the Project's proposed 499 units would be:

**3.60 Acres** = 
$$(499 \times 2.88) \times 0.00251$$

The amount of land that is required to be dedicated is subject to change depending on the Park Service factor in effect at the time the Project is required to dedicate the land; the number of exempt dwelling units (e.g. affordable housing units, existing dwelling units to be replaced on site, etc.) included as part of the Project; any Dwelling Unit Construction Tax previously paid by the Project; and, any credits granted by RAP to the Project for improvements to dedicated park land or for eligible privately owned recreational facilities and amenities.

As currently proposed, the Project has 494 affordable units that would likely qualify for an exemption per LAMC Section 12.33 C.3. If those dwelling units are ultimately determined to be exempt, the maximum required land dedication for the Project would be:

**0.03 Acres** =  $(5 \times 2.88) \times 0.00251$ 

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Per LAMC Section 12.33 D.3, a project that is required to make a land dedication to the City may make said land dedication, or any portion thereof, either on-site or off-site of the project location. Any off-site land dedication must be located within a certain radius from the project site, as specified below:

- a) Neighborhood Park: within a 2-mile radius
- b) Community Park: within a 5-mile radius
- c) Regional Park: within a 10-mile radius

While the Advisory Agency has the authority to require the Project to dedicate land to the City for park purposes, the Board of Recreation and Parks Commissioners' (Board) would need to approve any proposed park land dedication before that land can be acquired and accepted by the City. Therefore, if the Advisory Agency requires the Project to dedicate land to the City, RAP staff would need to prepare a subsequent report to the Board regarding the proposed land dedication. That report would detail the amount and location of the land being dedicated, and the improvements, if any, proposed to be developed on the dedicated property. Additionally, if it is determined that the Project will provide a combination of land dedication and fee payment, the report would also identify the amount of in-lieu fees that would be owed to the City after RAP credits the Project for the amount of land being dedicated.

Per Section 66477 (7) of the California Government Code, "Only the payment of fees may be required in subdivisions containing 50 parcels or less, except that when a condominium project, stock cooperative or community apartment project, as those terms are defined in Sections 4105, 4125, and 4190 of the Civil Code, exceeds 50 dwelling units, dedication of land may be required notwithstanding that the number of parcels may be less than 50." The Project as described in this Report, is an apartment project.

#### In-Lieu Fee Payment

Pursuant to LAMC Section 12.33, the Park Fee amount is determined by the type of residential development project (Subdivision or Non-Subdivision) being developed. RAP shall collect these fees pursuant to LAMC Section 19.17 and the Park Fees Section of RAP's Rate and Fee Schedule. As of July 1, 2021, Residential Subdivision projects that are subject to the Subdivision fee shall pay:

#### \$16,642.00 x number of new non-exempt dwelling units

The **maximum** Park Fees payment for the Project's proposed 499 units would be:

 $\$8,304,358.00 = \$16,642.00 \times 499$  dwelling units

As currently proposed, the Project has 494 dwelling units that would likely qualify for an exemption per LAMC Section 12.33 C.3. If those dwelling units are ultimately determined to be exempt, the maximum required Park Fee payment for the Project would be:

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 $$83,210.00 = $16,642.00 \times 5$  dwelling units

The amount of Park Fees that are required to be paid is subject to change depending on the Park Fee schedule in effect in the year of payment; the number of exempt dwelling units (e.g. affordable housing units, existing dwelling units to be replaced on site, etc.) included as part of the Project; any Dwelling Unit Construction Tax previously paid by the Project; and, any credits granted by RAP to the Project for improvements to dedicated park land or for eligible privately owned recreational facilities and amenities.

Per LAMC Section 12.33 E.3, any Park Fees collected by the City shall be expended within a certain radius from the project site, as specified below:

- a) Neighborhood Park: within a 2-mile radius
- b) Community Park: within a 5-mile radius
- c) Regional Park: within a 10-mile radius

#### STAFF ANALYSIS AND RECOMMENDATION

In order for RAP staff to determine which mechanism, land dedication or payment of Park Fees, to recommend for the Board's review and approval, RAP staff analyzes each proposed development project including its location, new population, surrounding parks, any nearby active or proposed park acquisition or park development project, existing park service radius gaps, etc. RAP staff also analyzes any parks, open spaces, or recreational areas anticipated to be provided by each proposed development project in order to determine if those facilities would reduce the need for new public recreation and park facilitates to serve the project residents.

One of the most critical factors that RAP staff uses to analyze proposed developments is existing park service radius gaps. According to the Trust for Public Land 2022 Park Score Index, approximately 63% of residents in the City of Los Angeles live within a 10-minute walk, from a public park or open space. The Mayor's Office of Sustainability pLAn sets a goal of increasing the percentage of Angelenos living within a one-half mile from a park to at least 65% by 2025; 75% by 2035; and 100% by 2050. RAP has employed a variety of strategies, such as the 50 Parks Initiative, that are intended to increase park access and meet these park access goals.

#### Site Analysis

The Project is located within the Hollywood community of the City and within the Hollywood Community Plan Area. Currently, the Project site is an office building and parking lot. It is surrounded by commercial and residential uses on all sides.

An aerial view of the Project site is attached hereto (Attachment 3). A map showing the generalized zoning of the Project site and the Community Plan Area is also attached (Attachment 4).

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The Project is located in a high-density area of the City. Below is an analysis of the density of the area within walking distance of the Project site and a comparison to both citywide density and local community density:

- Half-mile walking distance of the Project site (EPADSS): 7,362 persons (23,006 persons per square mile).
- City of Los Angeles Population Density (2020 United States Census): 8,463 persons per square mile.
- Hollywood Community Plan Area (2016-2020 American Community Survey): 8,042 persons per square mile.

#### Project Open Space and Recreational Areas

As previously discussed, the Project also includes approximately 25,125 square feet of common open space, including an outdoor terrace on level 26, a public plaza, patio space, lobbies, a community center, business center, social services center, library, fitness center and outdoor walking paths.

The amount of common open space being provided by the Project does not appear to significantly exceed the amount of open space the Project would otherwise be required to provide per LAMC (or other planning documents, specific plans, etc.). Additionally, it does not appear that these open spaces will include the type and variety of active and passive recreational facilities and amenities that are typically found in the City's Neighborhood and Community Parks and that are needed to meet the needs of residents of all ages and abilities.

As currently proposed, these recreational amenities would likely not significantly reduce the Project's impact on existing public recreational and park facilities nor would they likely significantly reduce the need for new or expanded public recreational and park facilities.

#### Public Park Access

There are four (4) public parks within a one-half mile walking distance of the Project site:

- Carlton Way Park is a 0.19-acre park located at 5927 West Carlton Way in the Hollywood community of the City. The park provides a playground, outdoor fitness equipment and picnic areas for the surrounding community.
- Seily Rodriguez Park is a 0.34-acre park located at 5707 West Lexington Avenue in the Hollywood community of the City. The park provides a children's play area, picnic tables, benches and fitness equipment for the surrounding community.
- La Mirada Avenue Park is a 0.17-acre park located at 5401 West La Mirada Avenue in the Hollywood community of the City. The park provides outdoor fitness equipment and picnic tables for the surrounding community.

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• Lexington Avenue Pocket Park is a 0.17-acre park located at 5523 West Lexington Avenue in the Hollywood community of the City. The park provides a children's play area and picnic tables for the surrounding community.

A map showing the project location and nearby public parks is attached hereto (Attachment 5).

As previously noted in this Report, a land dedication for a new public park could be located either on-site or off-site of the Project location. If a new public park was provided at the Project location the park would serve the new residents of the Project and would serve approximately **2,584** new, previously unserved, residents within a half-mile walking distance (Attachment 6). If a new public park was provided off-site of the Project location the park would serve the new residents of the Project as well as an unknown number of new, previously unserved, residents within a half-mile walking distance. If the proposed Project does elect to make some or all of its required land dedication off-site, staff would work with the Project to identify a site that would serve project residents, help close an existing park service area gap, and maximize, to the extent feasible, the number of new residents who would be within a half-mile walking distance of a public park.

#### Nearby Public Park Projects

There are no new public parks currently in development within a two-mile radius of the Project site.

There are three (3) park renovation projects in development within a two-mile radius of the Project site that have previously been reviewed and approved by the Board and are currently fully funded:

- Griffith Park Boys Camp—Building Improvements (PRJ21196 PRJ21372) Project
- Griffith Park Girls Camp Camp Refurbishment (PRJ21197) (PRJ21373) Project
- Griffith Park Fern Dell Trails Cafe Renovations (PRJ21482) Project

There are nine (9) park renovation projects currently in various stages of planning and development within a two-mile radius of the Project site that are either still pending Board approval and/or are not currently fully funded:

- Barnsdall Park New Restroom (PRJ21125) Project
- Hollywood Recreation Center Modern Gymnasium (PRJ21112) (PRJ21441) Project
- Las Palmas Senior Citizen Center Facility Renovation (PRJ21175) (PRJ21176) Project
- Hollywood Recreation Center New Synthetic Field Project
- Griffith Park Commonwealth Nursery Project-- Horticultural Learning Center (Phase 2) (PRJ21189) Project
- Griffith Park Bronson Canyon Playground Replacement (PRJ21206) Project
- Griffith Park Bronson Canyon New Restroom (PRJ21207) Project
- Griffith Park Crystal Springs Crystal Springs Ballfield Project (PRJ20787)(PRJ21237)

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 Griffith Park Plunge Pool and Bathhouse - Pool and Bathhouse Renovation (PRJ21236 PRJ20271) Project

#### Staff Recommendation

RAP staff recommends that the appropriate mitigation measure for this proposed Project is the payment of in-lieu fees to the City as the majority of the apartment units will likely qualify for an affordable exemption and there are several projects within a two-mile radius that require additional funding in order to complete the proposed improvements.

#### FISCAL IMPACT

The potential Fiscal Impact to RAP's General Fund is unknown.

#### STRATEGIC PLAN INITIATIVES AND GOALS

Approval of this Board Report advances RAP's Strategic Plan by supporting:

Goal No. 3: Create & Maintain World Class Parks and Facilities

Outcome No. 3: Increased park maintenance, with a focus on cleanliness.

**Result:** Collected fees will mitigate the impact of the development on the park system and fund capital improvements at existing parks in the Project area.

This Report was prepared by Ajmal Noorzayee, Management Analyst, Planning, Maintenance and Construction Branch.

#### LIST OF ATTACHMENTS

- 1) Attachment 1 Conceptual Project Renderings
- 2) Attachment 2 Advisory Agency Filing Notice
- 3) Attachment 3 Aerial View of Project Site
- 4) Attachment 4 Zoning and Community Plan Map
- 5) Attachment 5 Project Location and Surrounding Parks
- 6) Attachment 6 EPADSS Report

# SkyVillage Hollywood


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SHEET INDEX				
Number	Sheet Name			
A.000	Cover			
G0	Existing Tree Plan			
L1	Overall Illustrative Site Plan			
L2	Ground Level Site Plan			
L3	Typical SkyVillage Garden Site Plans			
L4	Planting Palette			
L5	Planting Palette			
A 001	Project Data			
A 003	Area Tabulations			
A 004	Open Space Area Plans			
A 100	Lower Level Parking			
A.101	Level 1 Floor Plan			
A 102	Level 2 Floor Plan			
A 103	Level 3 - 22 Typical Floor Plan			
A 104	Level 23 - 24 Typical Floor Plan			
A 105	Level 25 Typical Floor Plan			
4.106	Mechanical and Amenity Level			
A 201	Elevation			
A 202	Elevation			
A 203	Elevation			
A 301	Section			







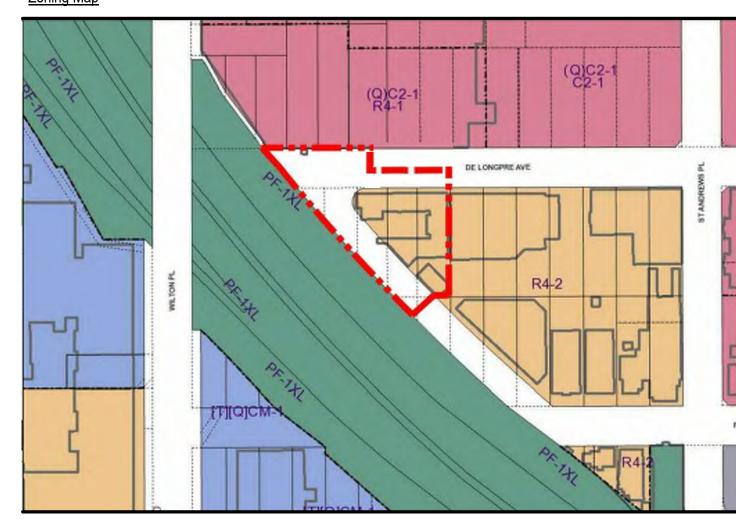

## Property Information

Property Information	<u>on</u>	<u>Project Team</u>		
Project Address:	5645 West Fernwood Ave., Hollywood, CA 90028	Owner:		
Site Address	5645 West Fernwood Ave and 5636 West DeLongpre Ave	ABS Fernwood, LLC 5500 West Hollywood Blvd, 4th Floor, Los Angeles, CA 900		
APN(s):	5444-030-008	Architect:		
Tract(s):	Lemona Tract	Cuningham 8665 Hayden Place, Culver City, CA 90232		
Block:	Block 3	Landscape Architect:		
Lot(s):	FR 10	Communitas Design,LLC 1425 N Sierra Bonita Ave, Los Angeles, CA 90046		
ARB:	None	Civil Engineer: Land Design Consultants, Inc.		
Council District:	CD13- Mitch O'Farrell	800 Royal Oaks Drive, Suite 104, Monrovia, CA 91016		
Neighborhood Council:	Hollywood Studio District	Survey: Land Design Consultants, Inc. 800 Royal Oaks Drive, Suite 104, Monrovia, CA 91016		

#### Project Description

Building Type:	Type I-A
Primary Occupancy Type:	Group R-2 with S-2 Parking Garage

Building Description: New Construction - 26 Stories Apartment Building With One Level of Subterranean Parking Program Description:

Primary Occupancy of the Building is Affordable Senior Independent Living Apartment Units, with a unit mix consisting of 40 Studios, 452 One-Bedroom Units, 6 Two-Bedroom Units, and 1 Three-Bedroom Units (499 Total Units). Building amenities include community spaces, accessory occupancies including a leasing office with support functions, and parking with long-term and short term bicycle parking. Five of the 499 apartment units will be manager's units with unrestricted rent.

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Revision	ons	
No.	Date	Description


Project Information

Phase:	Concept Design	Date:	07/05/2022	
Project No.:	20-0296	PIC / AIC:		


SkyVillage Hollywood


Cover


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#### LEGEND:

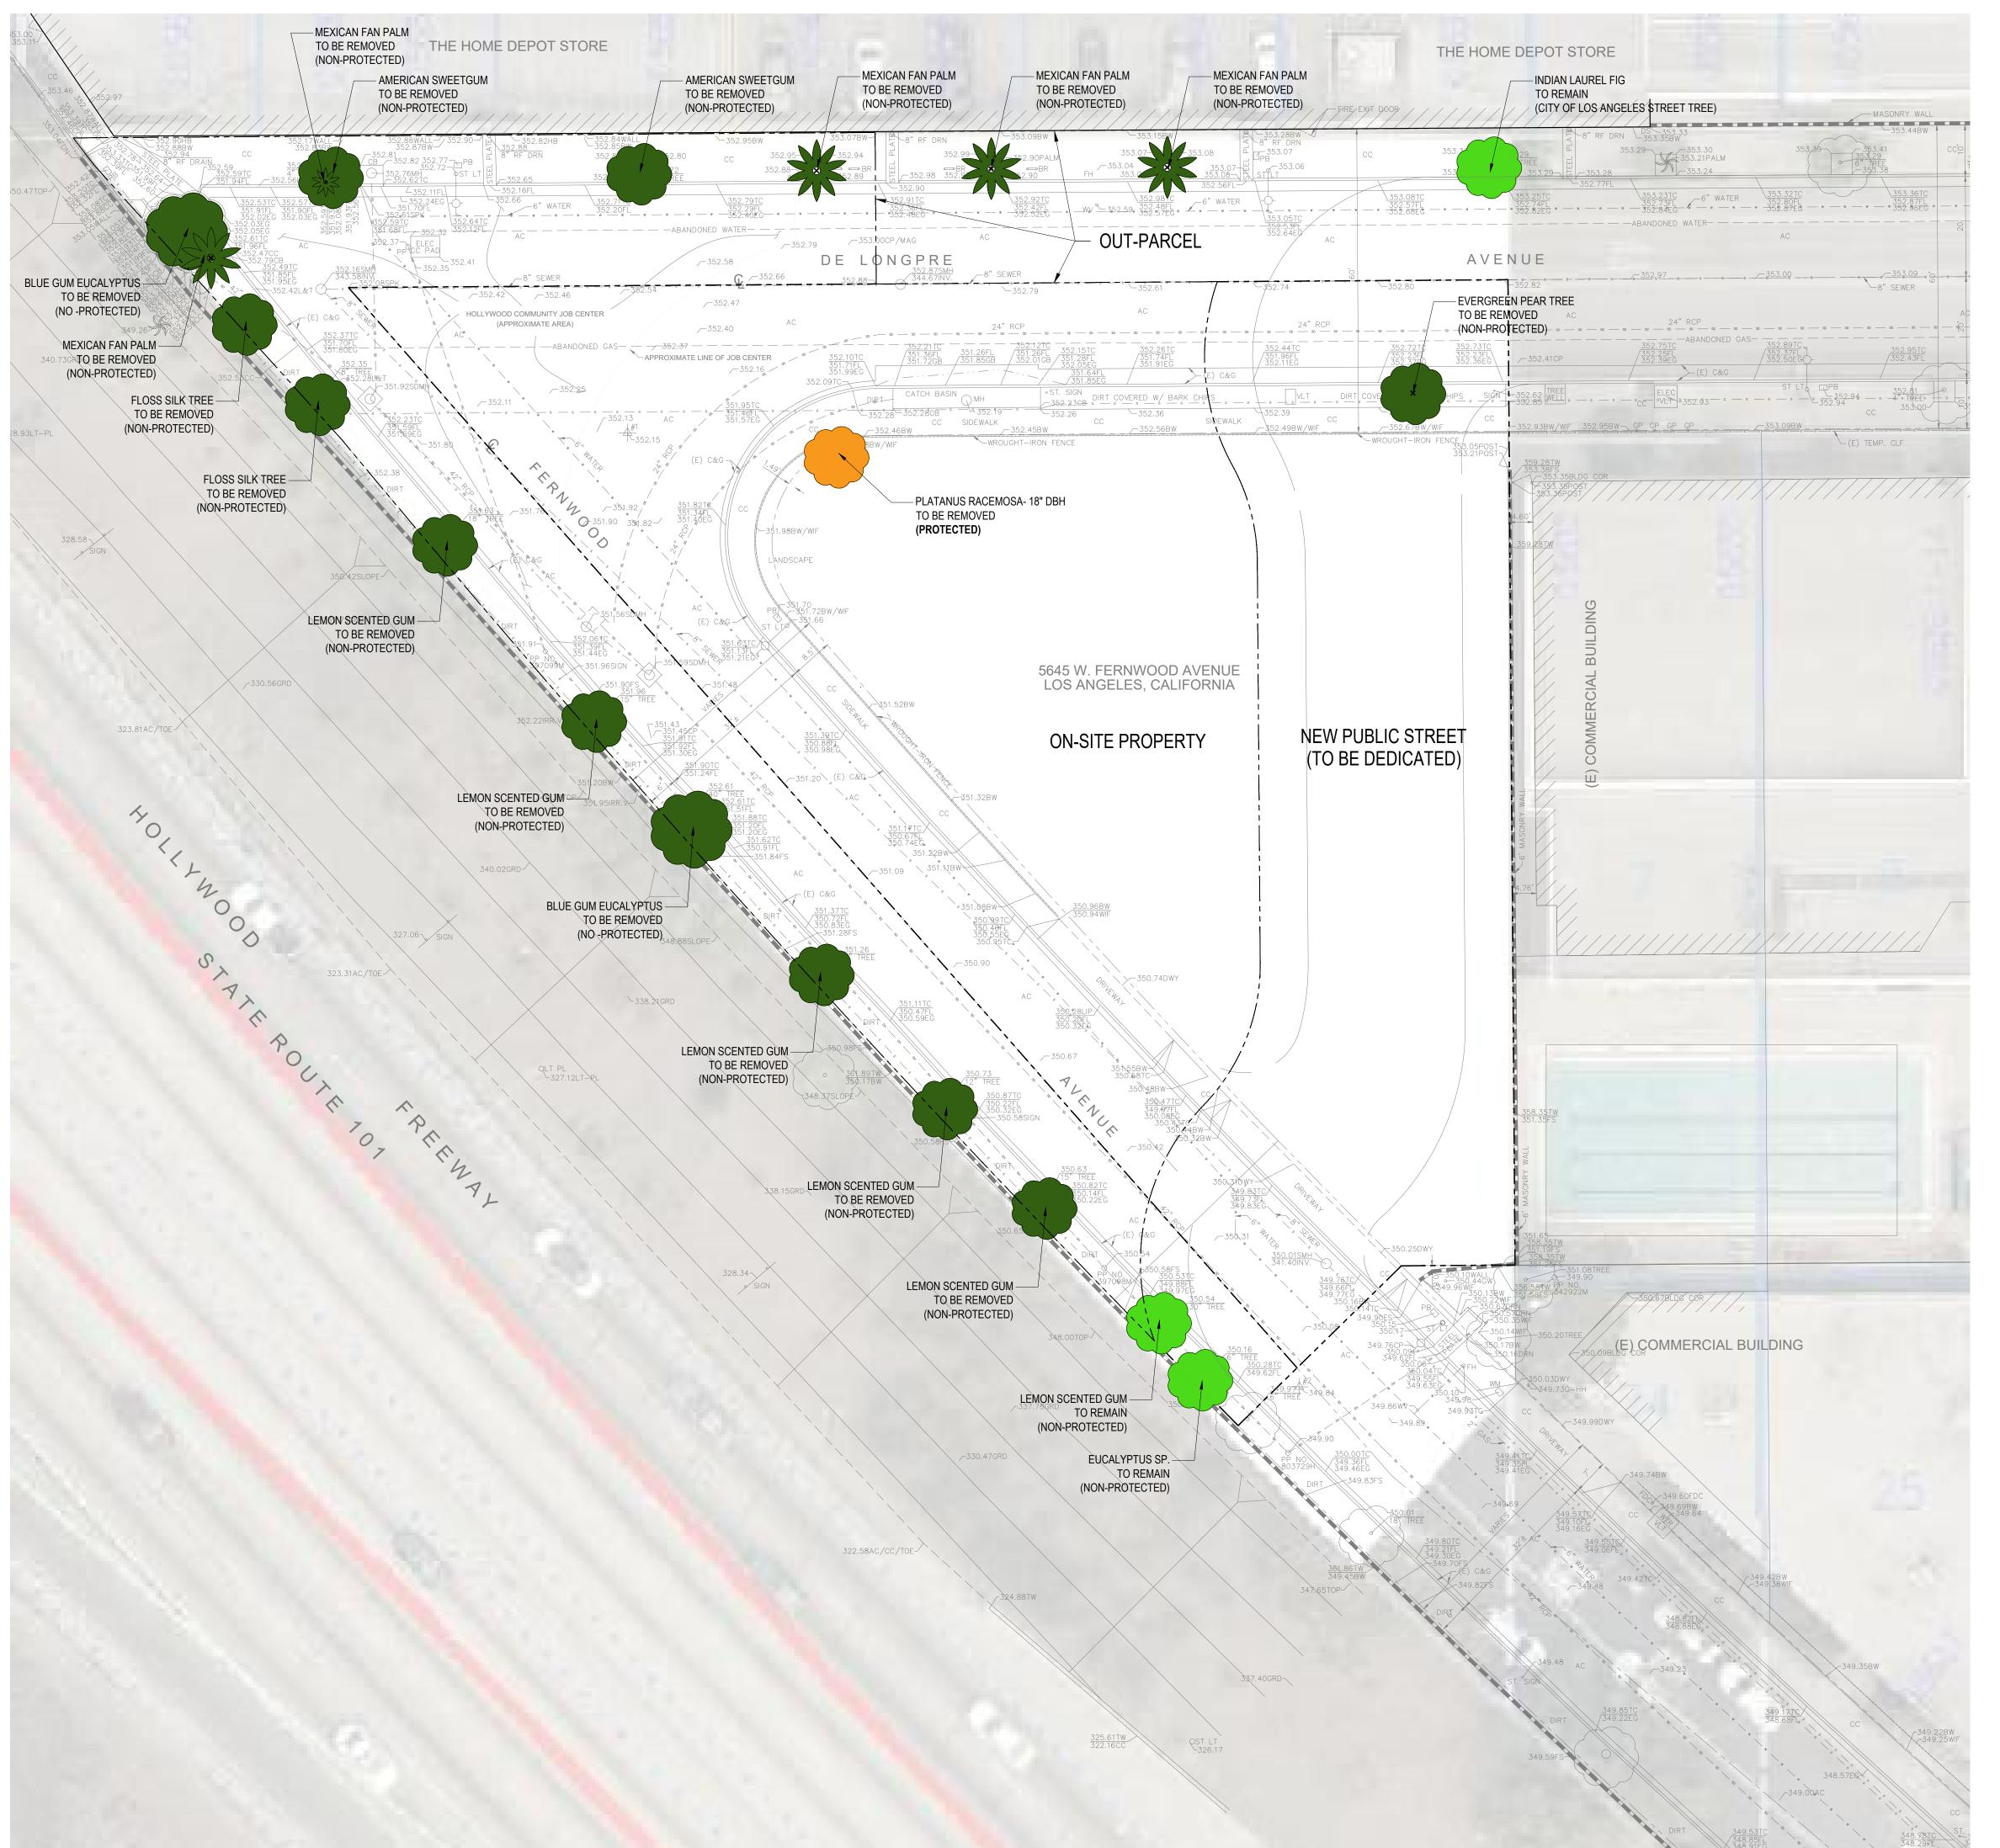



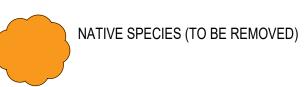

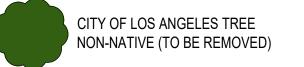
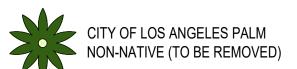
#### **EXISTING TREE PLAN SUMMARY:**

#### CITY OF LOS ANGELES STREET TREES:

SCALE: 1/16" = 1'-0"

- PROTECTED TREES 1
   CITY OF LA STREET TREES 17
   (NON-PROTECTED TO BE REMOVED)

   CITY OF LA STREET TREES 3
   (NON-PROTECTED TO REMAIN)

   TOTAL TREES TO BE REMOVED: 18
- (REFER TO SHEET L1 FOR TREE REPLACEMENT REQUIREMENTS)

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Revisions

No. Date Description

iost Information

Phase: Concept Design Date: 02/09/202

Project No.: 20-0296 PIC / AIC:

Skyvillage Hollywood

Sheet Title


**Existing Tree Plan** 

Sheet Number

Current Revision

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#### LANDSCAPE REQUIREMENT CHECKLIST:

THE FOLLOWING LANDSCAPE PLANS WERE DEVELOPED IN ACCORDANCE WITH THE FOLLOWING DOCUMENTS: • CITY OF LOS ANGELES LANDSCAPE ORDINANCE NO. 170.978, MAY 12, 1996

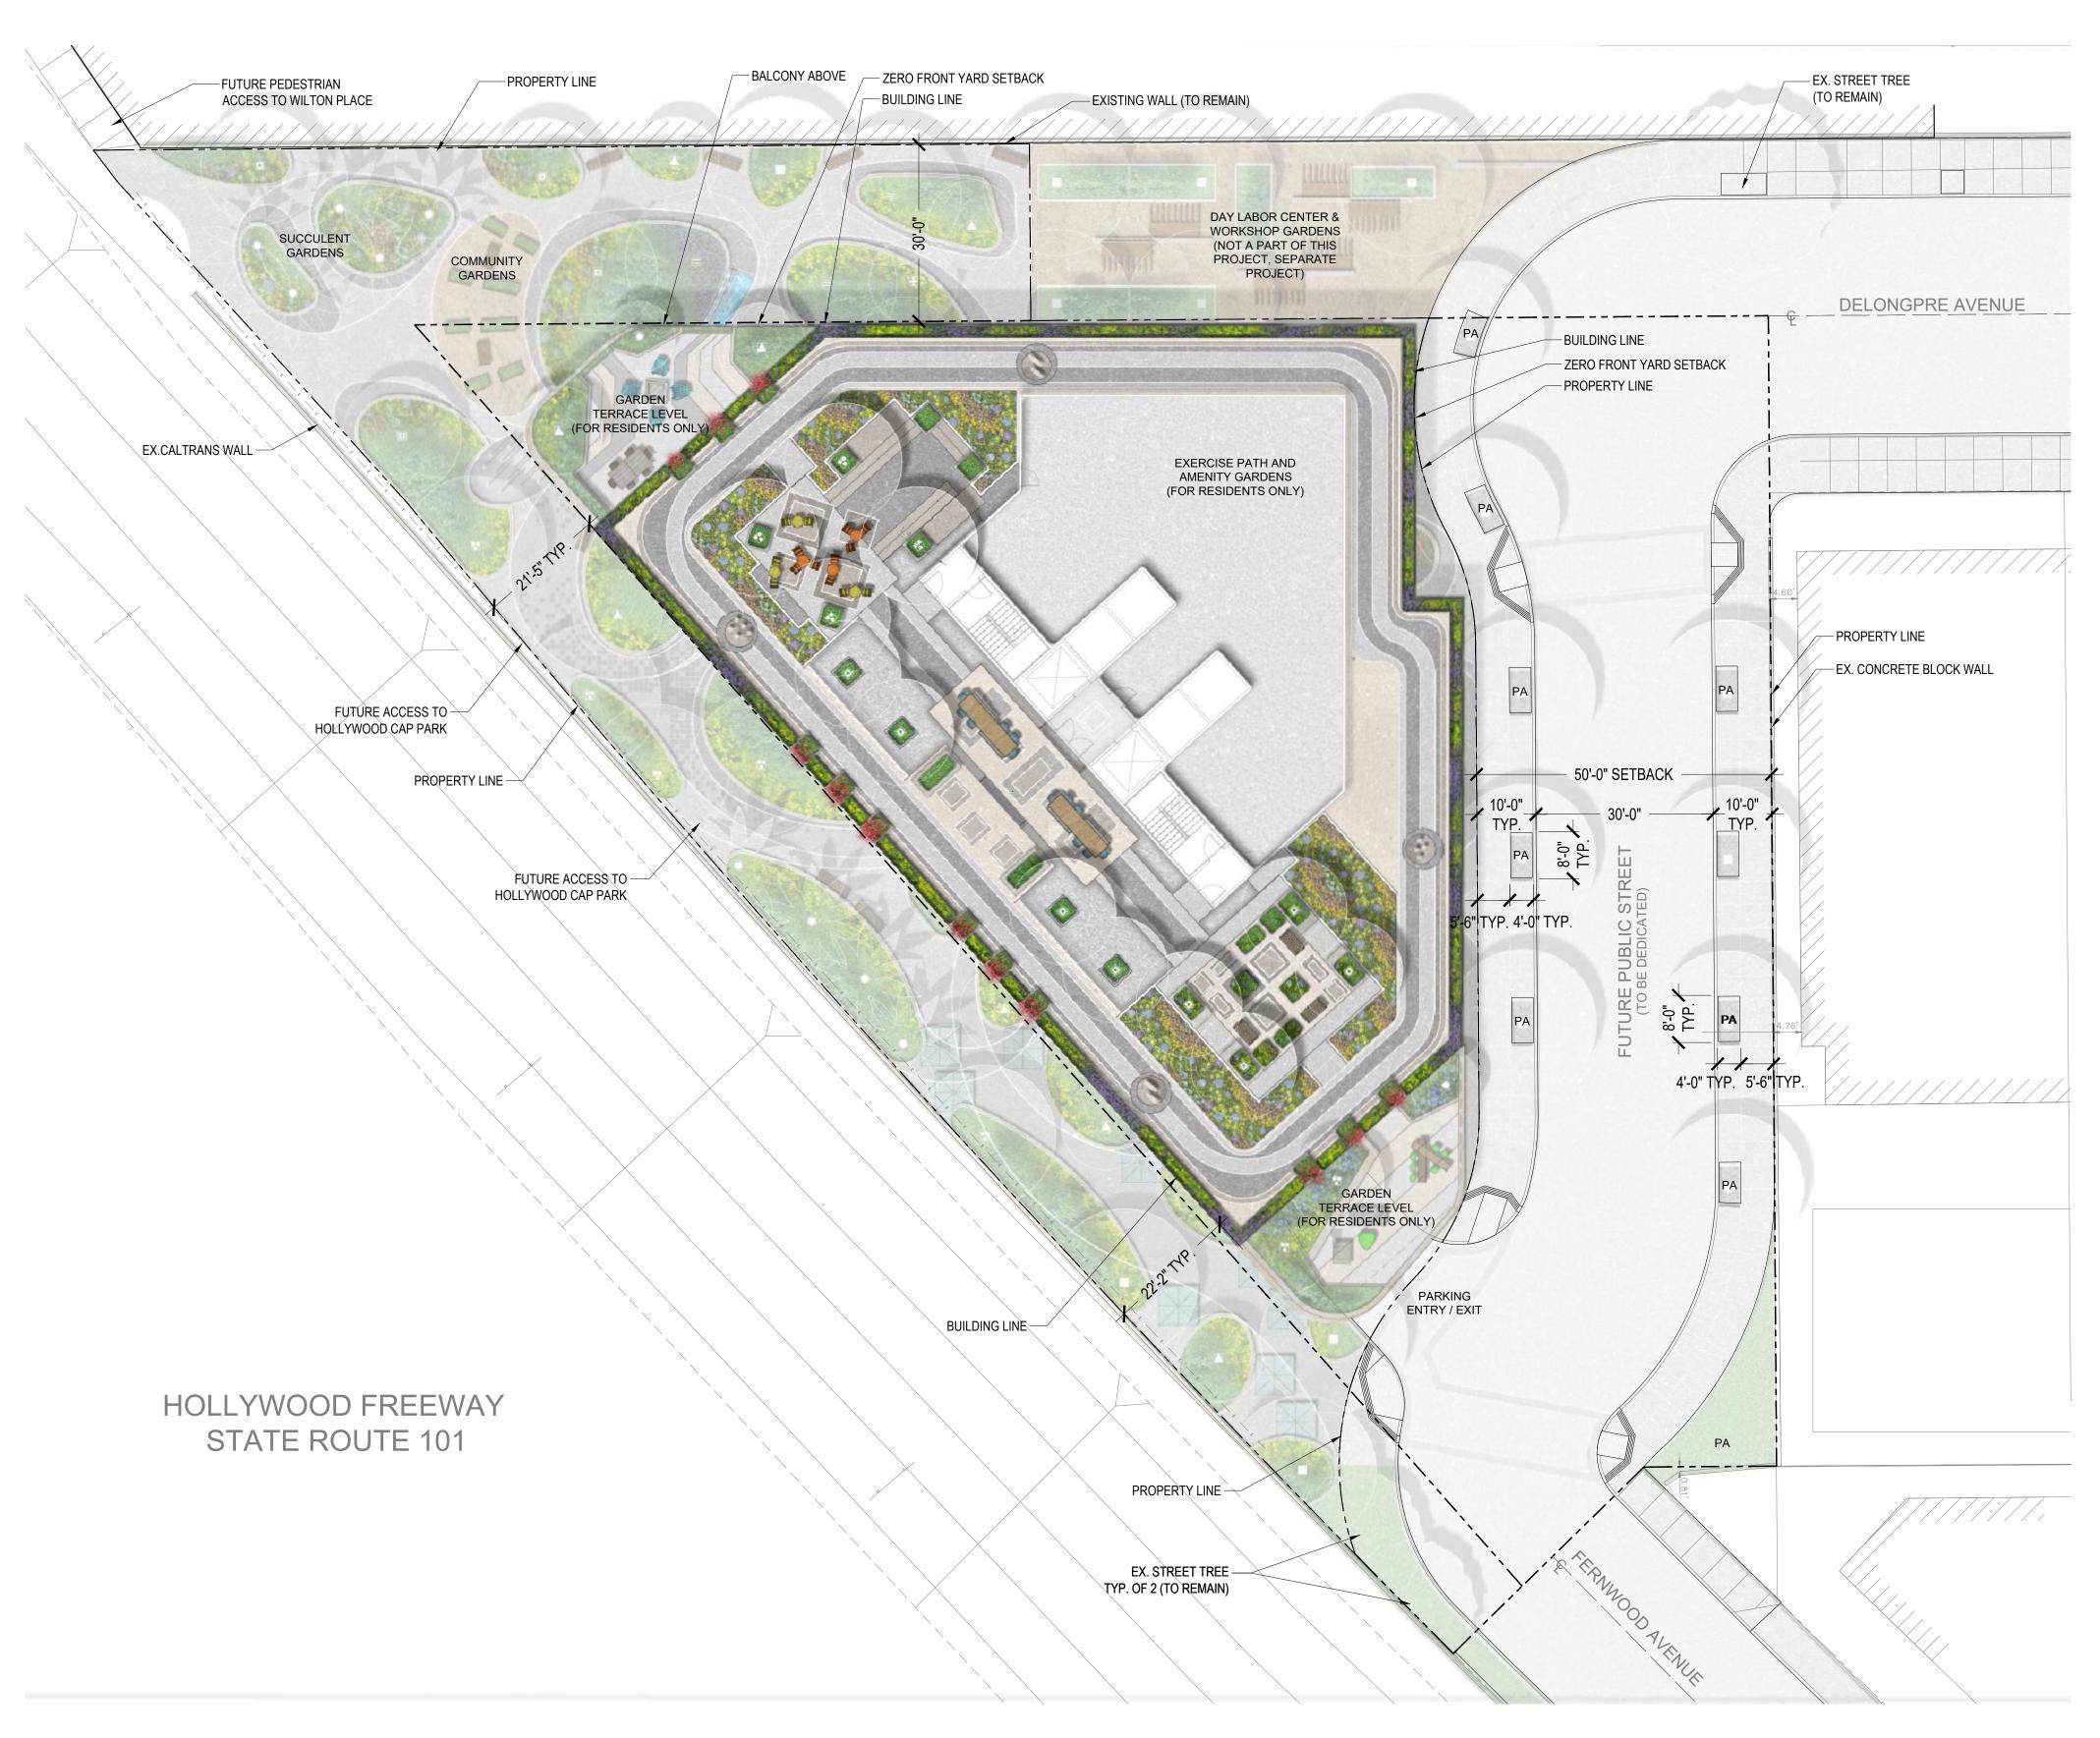• CITY OF LOS ANGELES LANDSCAPE ORDINANCE AMENDED GUIDELINES, MAY 20, 1993

• CITY OF LOS ANGELES MOBILITY PLAN 2035

#### SECTION 12.41.B. LANDSCAPE-WATER MANAGEMENT

12.41.B.2 ALL PERMANENT IRRIGATION SYSTEMS REQUIRED UNDER THE PROVISIONS OF THIS CODE THAT USE POTABLE WATER SHALL MEET THE MINIMUM SPECIFICATIONS FOR FEATURES AND TECHNIQUES ESTABLISHED BY THE CITY PLANNING COMMISSION.

#### SECTION 12.42 C. LAMC - TREES

12.42.C.1A AT LEAST ONE TREE, WHICH SHALL NOT BE A PALM, SHALL BE PROVIDED IN THE PROJECT FOR EACH 500 SQUARE FEET OF LANDSCAPED AREA IN THE PROJECT. A MINIMUM OF 100 SQUARE FEET OF UNPAVED AREA SHALL BE PROVIDED AT THE BASE OF EACH TREE, THE SHORTEST DIMENSION OF WHICH SHALL BE 4 FEET MINIMUM, TO ALLOW FOR WATER INFILTRATION AND GAS EXCHANGE. TOTAL LANDSCAPE AREA IS 4,145 S.F. **REQUIRING (8) NEW TREES.** 

#### APPENDIX C

MITIGATION MEASURE BIO-3 REQUIRES THE REPLACEMENT OF ALL ON-SITE TREES TO ENSURE THE CONTINUATION OF THE URBAN FOREST. ALL NON-NATIVE TREES GREATER THAN 4" IN DIAMETER AT BREAST HEIGHT ARE TO BE REPLACED WITH NATIVE OR NON-NATIVE (NON-INVASIVE) TREES OF APPROPRIATE CLIMATE TOLERANCE. A QUANTITY OF (1) NATIVE PROTECTED SPECIES TREE ARE TO BE REPLACED AT A 4:1 RATIO, (17) CITY OF LOS ANGELES STREET TREES AT A 2:1 RATIO, AND (0) ON SITE NON-NATIVE TREES AT A 1:1 RATIO ARE TO BE REMOVED AND WILL BE REPLACED WITH A TOTAL QUANTITY OF (38) NATIVE OR CLIMATE APPROPRIATE TREES.

REQUIRES 1 TREE TO BE PLANTED ON SITE FOR EACH 4 UNITS. TOTAL UNIT COUNT IS (499 UNITS) REQUIRING (125) NEW TREES.

#### TREE REQUIREMENT SUMMARY:

ON-SITE.	
• 4,145 S.F. OF LANDSCAPE AREA REQUIRES 1 TREE PER 500 S.F.:	8
• (499) UNITS REQUIRES 1 TREE PER 4 UNITS:	125
TOTAL TREES REQUIRED:	133

#### CITY OF LOS ANGELES STREET TREE OFF-SITE:

• (1) NATIVE TREE SPECIES REPLACE 4:1 RATIO: • (17) NON-NATIVE TREE SPECIES REPLACE 2:1 RATIO TOTAL TREES REQUIRED:

#### PROJECT DESIGN NARRATIVE:

#### THE ROLE OF NATURE AND PATTERNS;

AS SCIENCE AND TECHNOLOGY BECOME CLOSELY KNIT PARTNERS IN THIS FAST PACED WORLD, IT IS THE NATURAL ENVIRONMENT WHICH ILLUSTRATES THE BEAUTY OF EVERLASTING SHAPE AND STRUCTURE. NATURE IS A COMPLEX SYSTEM YET APPEARS TO BE SIMPLE BECAUSE OF THE SLIGHT VARIATIONS OF ITS RESPECTIVE EVOLUTIONARY JOURNEY. NATURE'S SHAPES ARE BASED ON MATHEMATICAL AND NATURAL PHENOMENON KNOWN AS FRACTALS. FRACTAL PATTERNS ARE REPEATED AT DIFFERENT SCALES AS NATURE ADAPTS, GROWS, AND PROTECTS ITS VERY SURVIVAL.

THIS PROJECT'S GOAL IS TO CREATE A PLAZA WITH PROGRAMMATIC OUTDOOR ROOMS THAT RELY ON THE FRACTAL PATTERNS TO EMBRACE VISITORS AND ENHANCE THEIR EXPERIENCE. THESE OUTDOOR AREAS ARE CREATED THROUGH REPEATING, RANDOMIZING AND REPLICATING THE FORMS OF NATURAL PLANT GROWTH AND USING THEM AS A UNIFYING ELEMENT TO DEFINE THE GREAT PLAZA AS THE MOST UNIQUE PUBLIC/PRIVATE OPEN SPACE IN HOLLYWOOD.

OPPORTUNITIES TO APPLY THESE PATTERN CONCEPTS EXIST AT THE GREAT PLAZA, ENTRY COURTYARD, ARCHITECTURAL TERRACES AND ALL OUTDOOR GARDEN AREAS WITHIN THE SCOPE OF THIS PROJECT. BY ELEVATING OUR UNDERSTANDING OF THE MIRACLES OF NATURE, HOLLYWOOD RESIDENTS WILL EXPERIENCE A DEEPER UNDERSTANDING THAT OUR PHYSICAL, SENSORY, SOCIAL, EMOTIONAL HEALTH AND WELL-BEING CAN BE GREATLY IMPROVED WHEN WE LOOK TO NATURE FOR THE ANSWERS.

#### GENERAL APPROACH TO LANDSCAPE DESIGN:

THE LANDSCAPE AND IRRIGATION SCOPE OF WORK WILL BE IN COMPLIANCE WITH ALL APPLICABLE FEDERAL, STATE, REGIONAL, COUNTY, CITY, AND LOCAL CODES, STANDARDS, AND SPECIFICATIONS. THE DESIGN APPROACH WILL BE PRESENTED AND APPROVED BY THE CLIENT AND THE APPROVED CONCEPT DESIGN WILL ACT AS A GUIDE THROUGHOUT THE DOCUMENTATION PROCESS TO ENSURE REGULATORY COMPLIANCE.

#### APPROACH FOR PLANTING MATERIALS:

THE LANDSCAPE PLANTING STRATEGY IS TO REDUCE WATER CONSUMPTION FROM POTABLE IRRIGATION WITH THE USE OF CALIFORNIA NATIVE PLANT MATERIAL THAT ARE DROUGHT TOLERANT AND WATER-WISE EFFICIENT. THIS APPROACH CAN BE ACHIEVED BY A VAST ARRAY OF LOCAL PLANT MATERIAL (PREFERRED) AND ACCENTED BY PLANT MATERIAL FROM SIMILAR CLIMATES TO CREATE A RICH PLANTED ENVIRONMENT WITH A VARIETY OF TEXTURES, HEIGHTS, AND COLORS. ANOTHER ENVIRONMENTAL-FRIENDLY APPROACH TO CREATING BALANCE WITH THE DEVELOPMENT IS CREATING AREAS FOR RAINWATER HARVESTING. COLLECTING RAIN WATER RUNOFF PROVIDES AN INDEPENDENT WATER SUPPLY FOR IRRIGATION AND/OR CAN BE USED TO FILTER RUNOFF FOR GROUND WATER RECHARGE.

#### APPROACH FOR HARDSCAPE MATERIALS:

SELECTING HARDSCAPE MATERIALS THAT ARE FOUND LOCALLY OR REGIONALLY ARE IDEAL FOR THE ENVIRONMENT. LOCAL OR REGIONAL PRODUCTS ARE GOOD FOR THE ENVIRONMENT BECAUSE OF THE REDUCED COSTS AND IMPACTS OF MATERIAL DELIVERY. IN ADDITION, PAVING MATERIALS THAT ARE PERMEABLE, ASSIST IN ABSORBING RAINWATER RUNOFF AND ADD TO THE AMOUNT OF WATER COLLECTED FOR GROUNDWATER RECHARGE. ANOTHER ENVIRONMENTALLY SOUND DESIGN CHOICE IS TO SELECT PAVING MATERIALS THAT HAVE HIGH SOLAR REFLECTANCE INDEX (SRI) WHICH ASSISTS IN MINIMIZING URBAN HEAT ISLANDS WITH THE REFLECTANCE OF SOLAR RAYS.

HARDSCAPE MATERIALS TO BE SELECTED FOR THE RIGHT-OF-WAY AREAS WILL COMPLY WITH THE CITY OF LOS ANGELES STANDARD MATERIALS LIST.

SCALE: 1/16" = 1'-0"



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Description


Project Information Concept Design Date: 02/09/2021 20-0296 PIC / AIC:

Skyvillage Hollywood

Overall Illustrative Site Plan

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#### LANDSCAPE CALCULATIONS:

OVERALL PROJECT SITE:			
<ul><li>EXISTING LOT AREA:</li></ul>	15,802 SF		
<ul><li>PROPOSED LOT AREA:</li></ul>	27,391 SF		
• PUBLIC STREET VACATION AREA:	11,773 SF		
BUILDING AREA:	16,435 SF		
OPEN SPACE:	10,956 SF		
<ul> <li>HARDSCAPE AREA (62%):</li> </ul>	6,811 SF		
• PLANTING AREA (38%):	4,145 SF		
SKYVILLAGE COMMON BALCONY:			
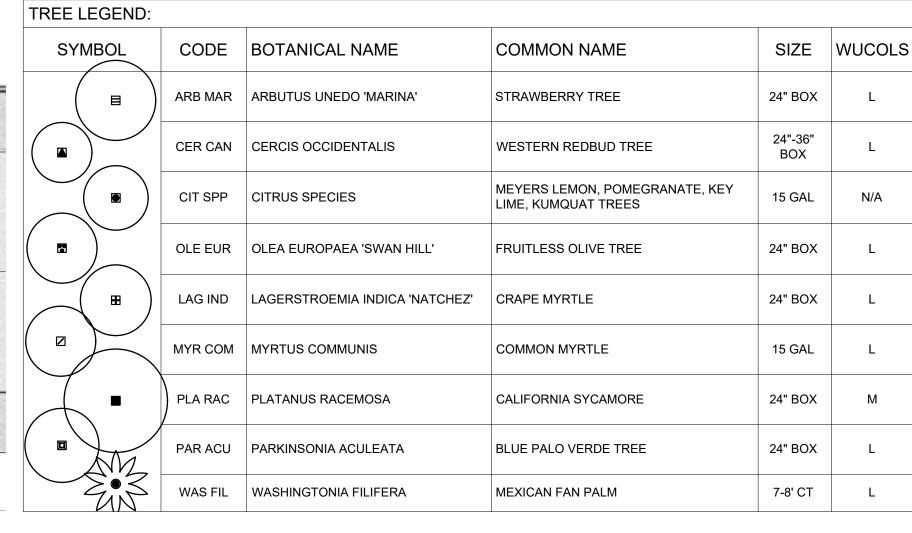
# (TYPES I, II)

(111 20 1, 11)	
• TYPE I OPEN SPACE (TYP. OF 9):	8,100 SF
• TYPE II OPEN SPACE (TYP. OF 9):	8,100 SF
• TOTAL HARDSCAPE AREA (75%):	12,150 SF
• TOTAL PLANTING AREA (25%):	4,050 SF

# **ROOF TERRACE LOUNGE:**

OPEN SPACE:	9,590 SF
• HARDSCAPE AREA (75%):	7,192 SF
• PLANTING AREA (25%):	2,398 SF

#### PERMEABLE LAND AREA CALCULATIONS:

# OVERALL PROJECT SITE:

OVERALL SITE AREA:	39,164 SF
PROPOSED LOT AREA:	27,391 SF
PUBLIC STREET VACATION AREA:	11,773 SF
OPEN SPACE:	10,956 SF
• NON-PERMEABLE PAVING AREA (62%):	6,811 SF
• PLANTING AREA (38%):	4,145 SF

# TREE REQUIREMENT SUMMARY:

ON-SITE GROUND LEVEL:		QTY.
• 4,145 S.F. OF LANDSCAPE AR	EA REQUIRES 1 TREE PER 500 S.F.:	8
• (1) NATIVE TREE REPLACE AT	Γ 4:1 RATIO:	4
• (17) NON-NATIVE TREES REP	LACE AT 2:1 RATIO:	34
• (499) UNITS REQUIRES 1 TRE	E PER 4 UNITS:	125
	TOTAL TREES REQUIRED:	171
	TOTAL TREES PROVIDED:	59
ON-SITE SKYVILLAGE BALCONY	:	
• LEVELS 3-27:		62
• ROOF GARDEN:		12
	TOTAL TREES PROVIDED:	74
	ON-SITE TOTAL TREES PROVIDED	): 133

# (0) STREET TREES REMOVED AND REPLACE 2:1: TOTAL TREES REQUIRED:

OFF-SITE GROUND LEVEL:

# TOTAL TREES PROVIDED: GRAND TOTAL TREES PROVIDED:

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Description

**Project Information** 

Concept Design Date: 20-0296 PIC / AIC:

Skyvillage Hollywood

Ground Level Site Plan

SCALE: 1/16" = 1'-0"

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FORMAL COMMUNITY GARDEN

EXERCISE PATH

AND AMENITY LOUNGE (FOR RESIDENTS

GREEN ROOF TRAY SYSTEM -

PERFORMANCE GARDEN

18" W SEATWALLS FOR -AMPHITHEATER TYP.

36" RAISED CONC. PLANTER WITH— EVERGREEN TREES TYP.

BISTRO TABLE -

AND CHAIRS

VINES TYP.

SIZED SHRUBS

42" HT RAISED PLANTER -FOR LARGE SHRUBS AND

42" HT. PLANTER POT WITH-

HANGING VINES AND MED.



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No. Date





LANDSCAPE CALCULATIONS:

ROO	F TERRACE LOUNG
	ODENI SDACE:

11001	I EINIMOL LOOM	
• OP	PEN SPACE:	
<ul> <li>HA</li> </ul>	RDSCAPE AREA (	75

OPEN SPACE:	9,590 SF
<ul> <li>HARDSCAPE AREA (75%):</li> </ul>	7,192 SF
<ul> <li>PLANTING AREA (25%):</li> </ul>	2,398 SF

Project Information Concept Design Date: 02/09/2021 20-0296 PIC / AIC: Project No.:

Description

Skyvillage Hollywood

Typical Skyvillage Garden Site Plans

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EXERCISE ACTIVITY NODE TYP.

OUTDOOR EXERCISE PATH TYP.

- GREEN ROOF TRAY SYSTEM

— 24" TO 30" RAISED CONC. PLANTER WITH SMALL AND MEDIUM FLOWERING SHRUBS TYP.

- 48"L OUTDOOR WOOD BENCH

—42" HT RAISED PLANTER FOR LARGE SHRUBS AND

— 42" HT. PLANTER WITH HANGING VINES AND MED. SIZED SHRUBS

VINES TYP.

42" HT RAISED CONCRETE
 PLANTER/SEATWALL
 FOR MEDIUM-SIZED FLOWERING TREE

- WIND SCREEN TYP. REFER TO ARCH DWGS.

ROOF TERRACE SITE PLAN SCALE: 1/8" = 1'-0"

PA

LARGE COMMUNAL TAB

- CONC. PEDESTAL

PAVERS TYP.

ARBUTUS 'MARINA' MARINA STRAWBERRY TREE




CERCIS OCCIDENTALIS
WESTERN REDBUD



LAGERSTROEMIA INDICA 'NATCHEZ' NATCHEZ CRAPE MYRTLE



MYRTUS COMMUNIS COMMON MYRTLE

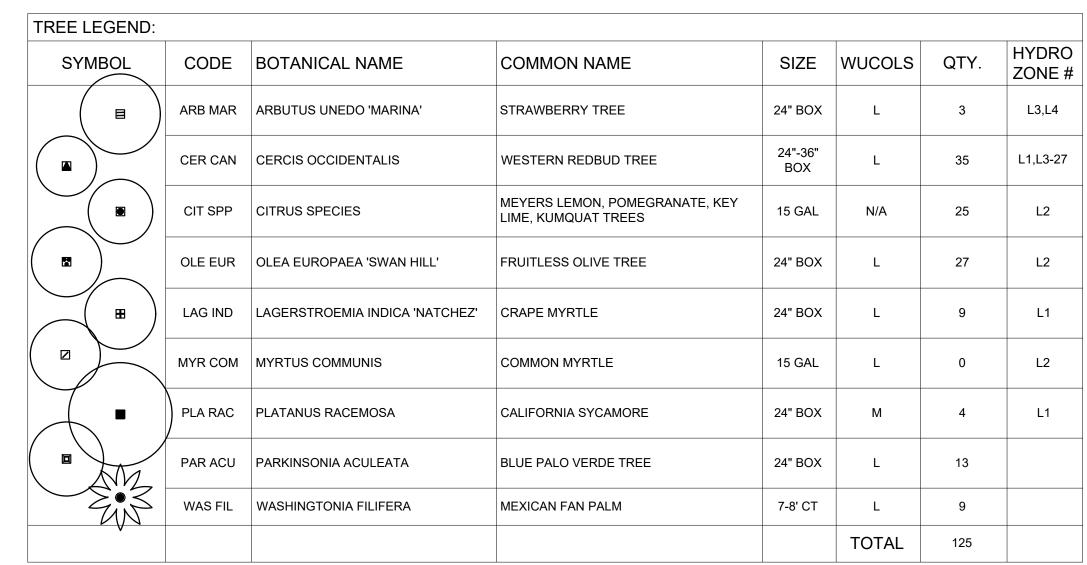



WASHINGTONIA FILIFERA MEXICAN FAN PALM



OLEA EUROPAEA 'SWAN HILL' SWAN HILL OLIVE (FRUITLESS)

ACACIA COGNATA 'COUSIN ITT'

LITTLE RIVER WATTLE

SHRUBS



PARKINSONIA ACULEATA
PALO VERDE TREE





TRISTANIOPSIS LAURINA 'ELEGANT'

**ELEGANT WATER GUM** 

ASPARAGUS DENSIIFLORUS ASPARAGUS FERN



CALLISTEMON 'LITTLE JOHN'
DWARF CALLISTEMON



CAREX PRAEGRACILIS
CLUSTERED FIELD SEDGE

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CEANOTHUS GRISEUS VAR. HORIZONTALIS 'YANKEE POINT' YANKEE POINT CEANOTHUS



ACHILLEA MILLEFOLIUM 'PAPRIKA'

PAPRIKA YARROW

COTONEASTER DAMMERI
'CORAL BEAUTY'
CORAL BEAUTY COTONEASTER




AGAVE ATTENUATA 'FOX TAIL'

FOX TAIL AGAVE

ENCELIA CALIFORNICA BUSH SUNFLOWER



JUNCUS PATENS CALIFORNIA GRAY RUSH

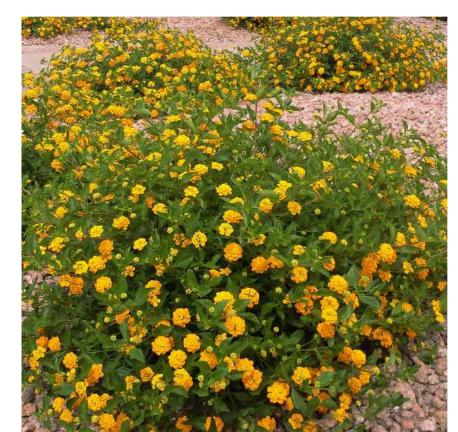

LANTANA 'MONET' SPREADING SUNSET LANTANA



LEUCOSPERMUM 'VELDFIRE' VELDFIRE PINCUSHION

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Revisions	
	<b>-</b>

Project Information

Phase:	Concept Design	Date:	02/09/20
Project No.:	20-0296	PIC / AIC:	
<u> </u>	1.1.11	ı	

Skyvillage Hollywood

ioot Hao

Planting Palette

et Number

\_4

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DWARF MAT RUSH



MUHLENBERGIA DUBIA PINE MUHLY



PHILODENDRON 'XANADU' WINTERBORN PHILODENDRON

GROUNDCOVER



POLYSTICHUM MUNITUM WESTERN SWORDFERN



ROSA CALIFORNICA CALIFORNIA WILD ROSE



ROSMARINUS OFFICINALIS 'PROSTRATUS' CREEPING ROSEMARY



SALVIA SYLVESTRIS 'LITTLE NIGHT' LITTLE NIGHT MEADOW SAGE




WOODWARDIA FIMBRIATA GIANT CHAIN FERN




ARCTOSTAPHYLOS EDMUNDSII 'CARMEL SUR' CARMEL SUR MANSANITA



BACCHARIS PILULARIS 'PIGEON POINT' **COYOTE BRUSH** 

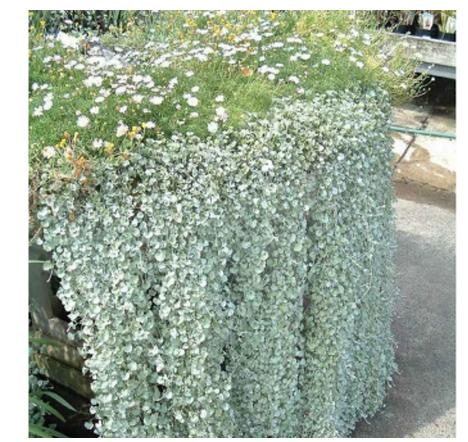

DICHONDRA ARGENTEA 'SILVER FALLS' SILVER DICHONDRA

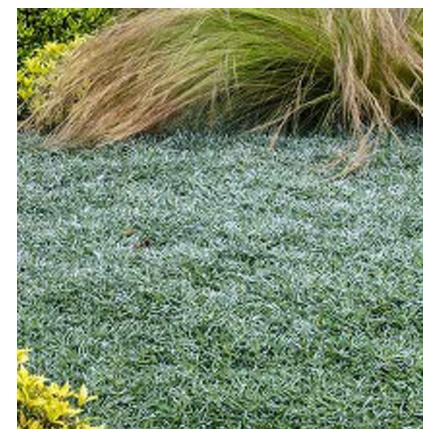

DYMONDIA MARGARETAE SILVER CARPET





**AEONIUM SPECIES** 



AGAVE ATTENUATA 'RAY OF LIGHT' RAY OF LIGHT AGAVE



ALOE ARBORESCENS TORCH ALOE



DASYLIRION LONGISSIMUM MEXICAN GRASS TREE



ECHEVERIA SPECIES



**Project Information** 

Concept Design Date: 20-0296 PIC / AIC:

Skyvillage Hollywood

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LOS ANGELES, CALIFORNIA 90046 (323) 828-4772 WWW. COMMUNITASDESIGN.COM

Planting Palette

VINES



BOUGAINVILLEA SPECIES



CISSUS ANTARTICA KANGAROO VINE



DISTICTIS BUCCINATORIA SCARLET TRUMPET VINE



TRACHELOSPERMUM JASMINOIDES STAR JASMINE



WISTERIA SINENSIS CHINESE WISTERIA

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An Affordable Residential Sanctuary for Seniors in an urban, vertical green space to Live,

*SkyVillage Hollywood* is located at 5645 Fernwood Ave. & 5636 Delongpre Ave., Los Angeles, California, in the Hollywood Studio District of Los Angeles, and adjacent to the proposed future Hollywood Central Park in the heart of Hollywood and also located within walking distance to the Hollywood/Western Transit Station.

SkyVillage brings together sustainability, accessibility, affordability and the re-imagining of public and private space into a 21st Century model of transit-oriented affordable living in the heart of Hollywood.

SkyVillage, is a proposed new construction, multi-family Senior - 100% affordable senior residential development located near the Red Line Metro Station at Hollywood/Western and within walking distance to some of Hollywood's prominent employers like Paramount Studios, Sunset Gower Studios, Netflix to the west, Kaiser Permanente and Children's Hospital to the East.

SkyVillage will provide much needed senior affordable housing in Hollywood with the construction of a Type-I residential high rise, which is designed to be approximately 26 stories tall (approximately 300' 2") to comprise of up-to 499 affordable residential units on levels 3 to 25.

The project seeks to alleviate, through intelligent design, some of the ill effects of living in a dense urban environment related to the proximity to freeways, prone to noise, pollution and lack of open spaces. The project has been designed to help mitigate and/or alleviate some of these concerns through proposed design elements that are incorporate on the side of the building facing the freeway, like green screens on patios, smog eating concrete skin on lower levels, landscaping art pieces that absorbs smog, etc.

The development as proposed is a 100% affordable residential project with a mix of Studiounits, one-bedroom and two-bedroom units restricted to rental for Senior tenants with AMI in the Moderate, Low Income and Very Low-Income categories.

The development will also comprise of a ground level publicly accessible 'Village Plaza', bike parking, ride share spaces, leasing offices and amenities on the first level, the roof deck level sits high above the City and has been designed to serve the resident Senior population. The design encourages tenants to spend outdoor time on the rooftop with a 300'+ walking track, with herb gardens and exercise stations along with seating areas with tremendous views of the City at Sunrise and Sunset. a single level of subterranean parking with approximately 54 spaces will provide access to ride share pickups, service provider and administrative parking. The proximity to public transit and ride share facilities is a critical component for the project since most of Target population being served is not expected to own personal automobiles.

The Village Plaza on the ground floor includes the double-height space under the building footprint, and the entire open space will be accessible to the public. The Village Plaza will bring a variety of public amenities such as open spaces, walkways, landscaped areas which can be activated for street festivals, events, and other neighborhood-friendly attractions.

The creation of the *Village Plaza* will be achieved by re-designing an existing tight blind turn on the corner of Fernwood and Delongpre Avenue, an area that is bounded by the 101freeway sound wall and is currently experiencing severe urban blight street vacation. A proposed street vacation and re-designed local street will result in improved vehicular and pedestrian access to local streets, while re-imagining the blighted corner into a privately funded publicly accessible amenity space.

The Village Plaza and its amenity spaces will be funded, maintained and managed as part of the residential project's operations with the intent to alleviate the blight and a substantial lack of open/green space in the immediate neighborhood while maximizing the density of the affordable residential project.


The development of the plaza will generate numerous benefits for neighbors, residents, visitors and the City by eliminating the blight and providing access to well-maintained open and plaza space free for recreation and cultural activities. It will also bring other benefits typical when turning urban blight to green spaces. The development seeks to be a gateway to the Hollywood Central Park.

Another unique design feature, the undulating 'Sky Parks' on numerous levels sculpt the building exterior as well as provide outdoor community gardens for the residents and help frame the views of Hollywood and Downtown Los Angeles. Sky Parks will help bring "Green Space" into the vertical elevations of the building thereby further spreading our vision of a vertical, green and affordable Hollywood. The proposed Sky Parks increase the available open and green spaces for residents of the vertical village. The Sky parks are oriented to face away from the freeway and the use of planted screens and lush landscaping will create an outdoor park type environment high above the traffic filled streets.


This innovative design feature will help distribute the open space usage amongst the residents while ensuring that the plaza/open space is available to the general public with a focus to integrating the design of the proposed Hollywood Central Park with the project.


Hollywood is growing and at the forefront of smart, dense, and green community and economic development. Private and public spaces are revitalizing. Place-making is bringing culture and the arts to residents and visitors.

SkyVillage will continue this revitalization by bringing the private and public sectors together to forge a strategic partnership to encourage the innovative use of public and private space for the community's benefit.

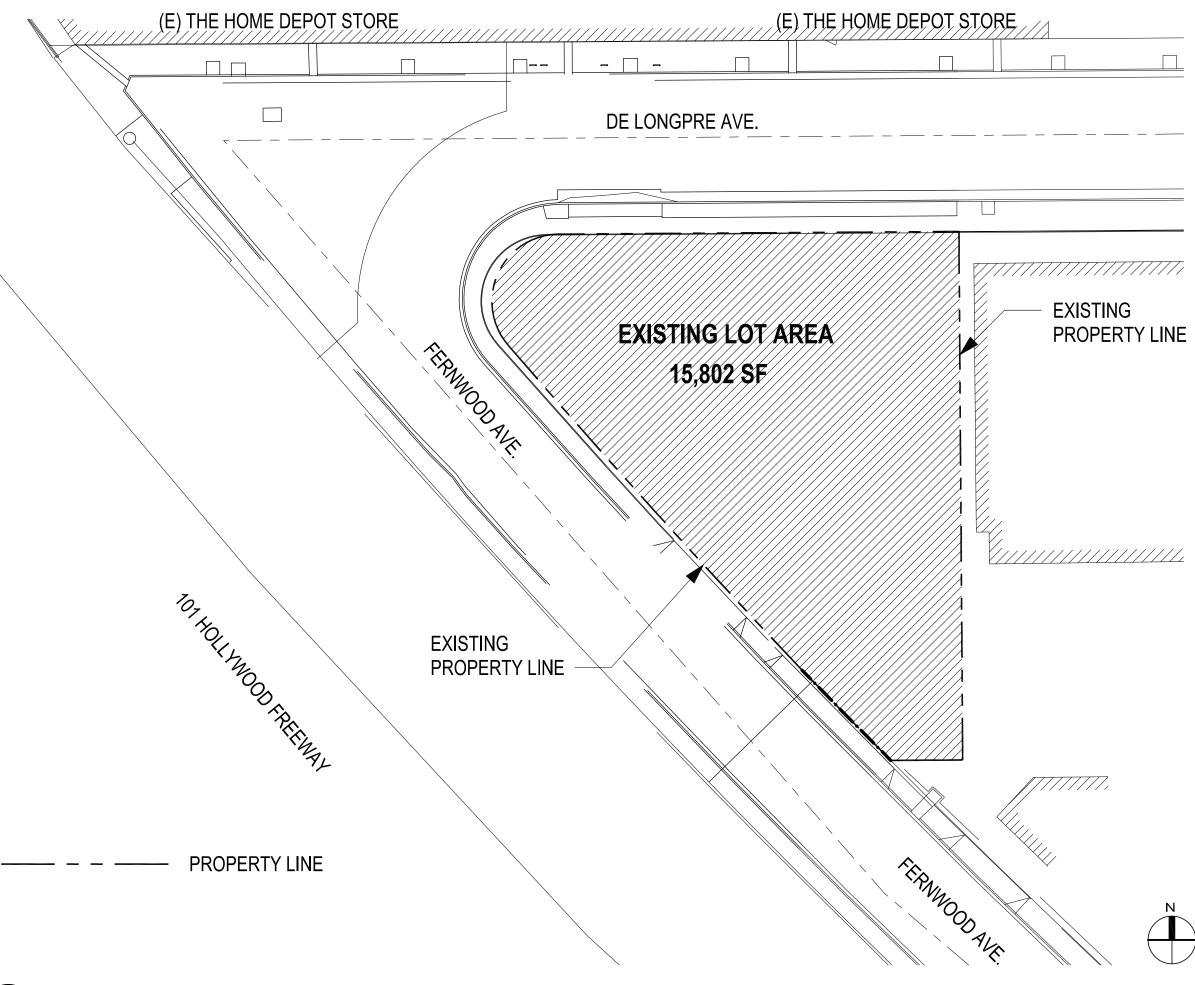



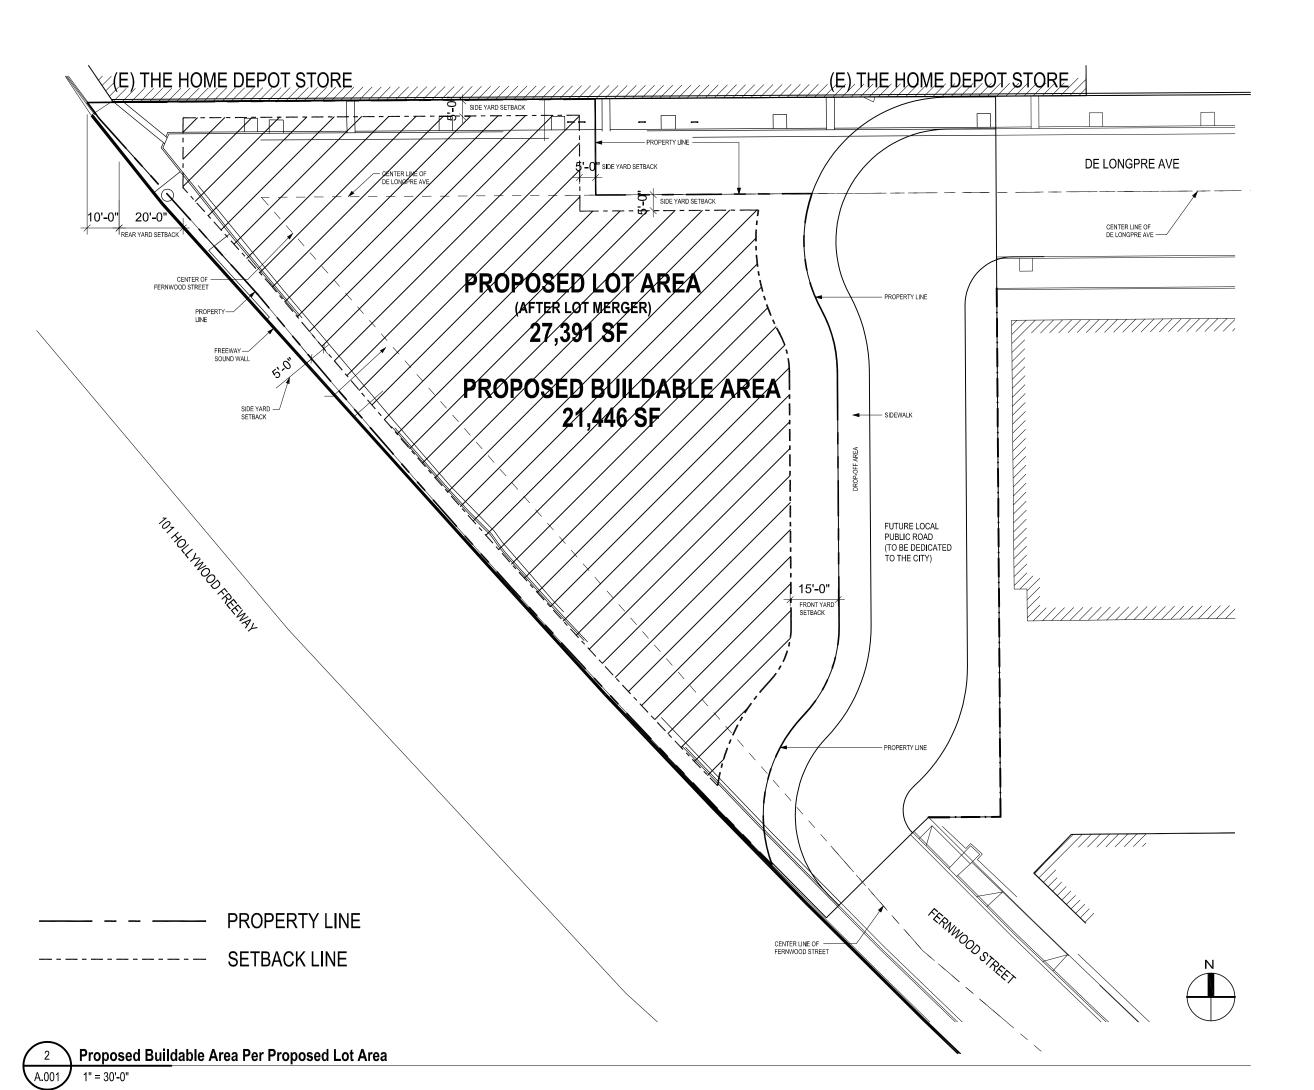

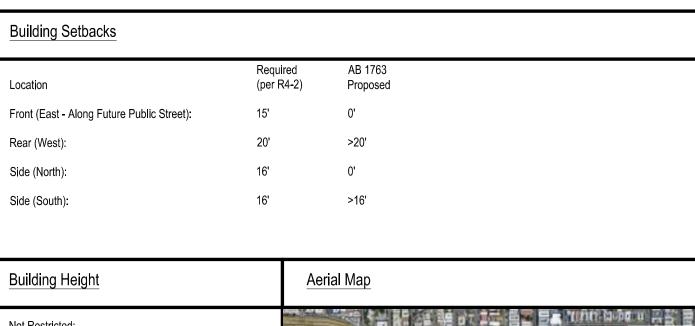

**Building Height** Not Restricted: Proposed Building Height: 300' - 2" Property Zoning R4-2 Property Zoning: Specific Plan Area: CDO: R4 (400 sf/du) Allowable Desnity Allowable FAR (LAMC): Maximum Height Transitional Height

#### Site Area & Floor Area (Residential or Mixed-Use)

Existing Lot Area: 15,802 sf Proposed Lot Area (After Lot Merger): 27,391 sf Proposed Buildable Area: 21,446 sf FAR 6:1 (Based on Above Buildable Area): 128,676 sf

Proposed Floor Area: **368,425 sf** (Per incentive listed below - refer to General Notes below)

Density

C2 Zone (R4 Density): 1:400 Base Density (By-Right): 69 Units

State Density Bonus: No limit for project within 1/2 mile of major transit stop (Refer to aerial map above)

The site is located in a TOC Zone 3.

Units Proposed: 499 Units

(Unlimited density per AB1763 - refer to General Notes below)

#### Open Space Requirement

Open Space Required

Studios:  $40 \text{ units } \times 100 \text{ sf/unit} = 4,000 \text{ sf}$ 1-BR: 452 units x 100 sf/unit = 45,200 sf 2-BR: 6 units x 125 sf/unit = 750 sf3-BR: 1 unit x 175 sf/unit = 175 sf

50,125 sf Total area required: Total area provided: 25,125 sf

(Refer to Sheet A004 for Open Space calculation, which does not include the ground floor plaza under

the building nor balconies on the typical levels. SEe General Notes below for Open Space incentive).

# Parking

Parking required: Not required for 100% affordable housing. Parking required for 5 Manager Units (One-Bedroom units) is 1.5 cars per unit = 8 minimum parking stalls

Total parking spaces provided: 54 stalls

Bicycles Requirment:

Long Term 3 (1/10 Units) 25 (1/1 Unit) 50 (1/1.5 Units) 26-100 5 (1/15 Units)

101-200 5 (1/20 Units) 50 (1/2 Units) 201-499 8 (1/40 Units) 75 (1/4 Units)

Bicycles

Bicycles Required Total = 221 Provided Total: 225

**General Notes** 

Project proposes demolition of the existing surface parking lot and the construction of a new 100% affordable

housing project with 499 dwelling units, with 80% of total units reserved for Lower Income households and the remaining 20% of units reserved for Moderate Income households.

Pursuant to State density bonus law (California Government Code Section 65915), the Applicant qualifies for unlimited density up plus up to four additional incentives/waivers in conjunction with developing a 100% affordable housing project in compliance with AB 1763. Pursuant to State density bonus law, the Applicant requests the following incentives/waivers:

1. Increase floor area to permit 368,425 square feet of floor area

2. Zero foot side yard setback (northerly setback)

3. Zero foot front yard setback (along future public street) 4. Open space provided reduced to 25,125 square feet

**Project Data** 

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No. Date Description

Project Information

Concept Design Date: 20-0296 PIC / AIC:

SkyVillage Hollywood

**Current Revision** 

**Building Area** 

290 SF

14,715 SF

14,715 SF

14715 SF

260 SF

Detail

Detail 2

Detail 3

Detail 4

Level

Level 1 Area

Level 2 Area

Level 3 Area

Level 4 Area

Level 5 Area

Level 6 Area

Level 7 Area

Level 8 Area

Level 9 Area

Level 10 Area

Level 11 Area

Level 12 Area

Level 13 Area

Level 14 Area

Level 15 Area

Level 16 Area

Level 17 Area

Level 18 Area

Level 19 Area

Level 20 Area

Level 21 Area

Level 22 Area

Level 23 Area

Level 24 Area

Level 25 Area

Level 26 Roof Detail 5

Level B1 Area Detail 1

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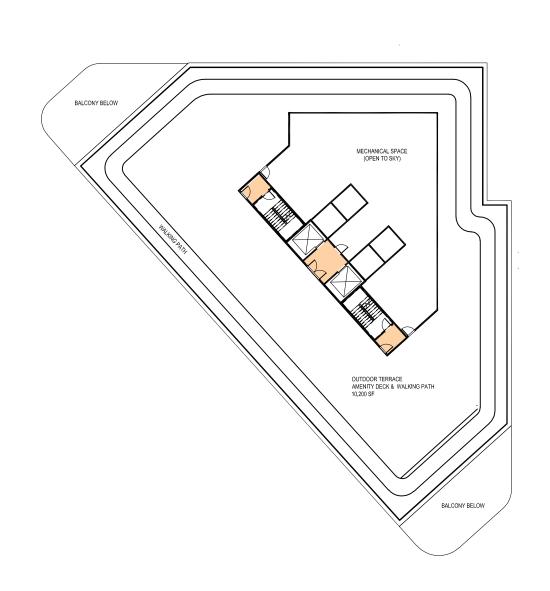
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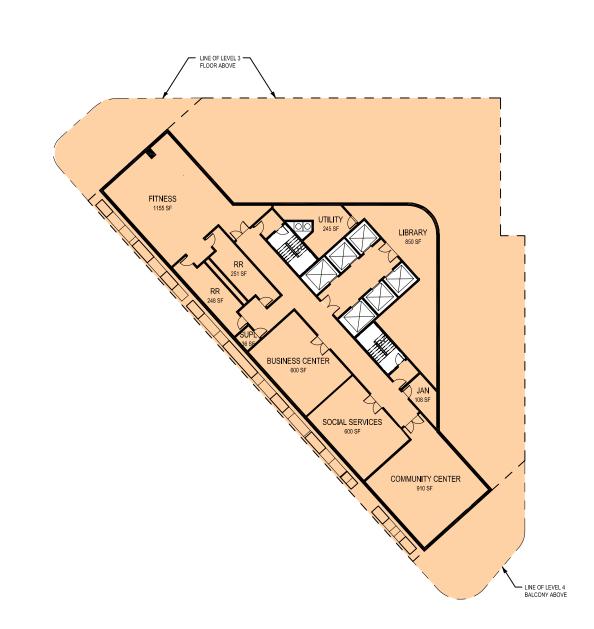
Concept Design Date: 20-0296 PIC / AIC:

SkyVillage Hollywood


Area Tabulation


**Current Revision** 






5 Level 26 Amenity/Mechanical - Floor Area
A.003

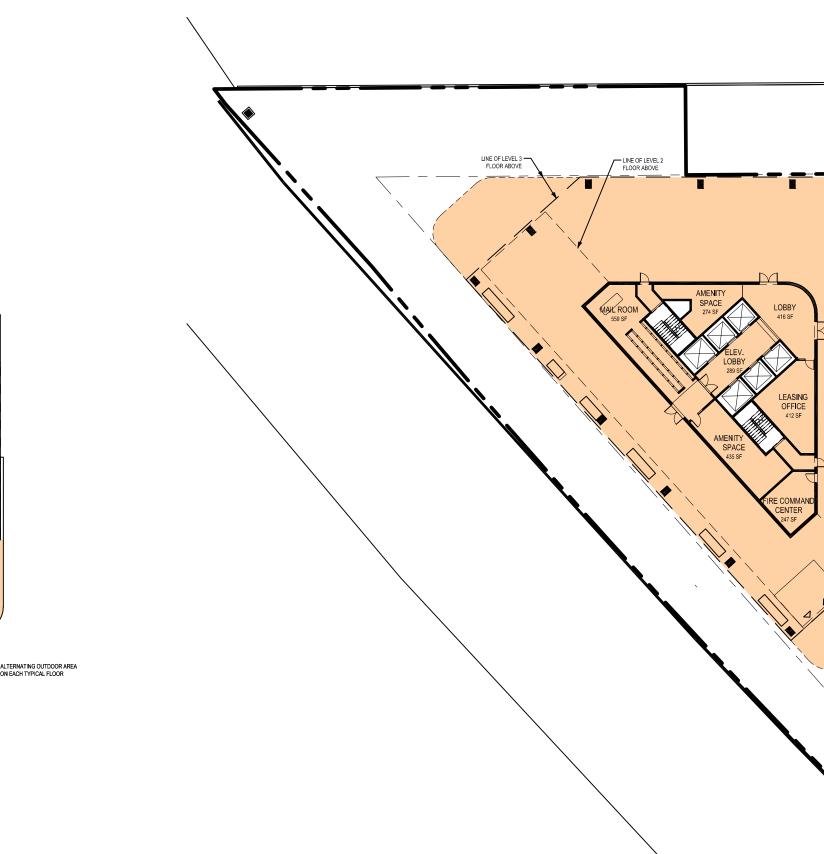

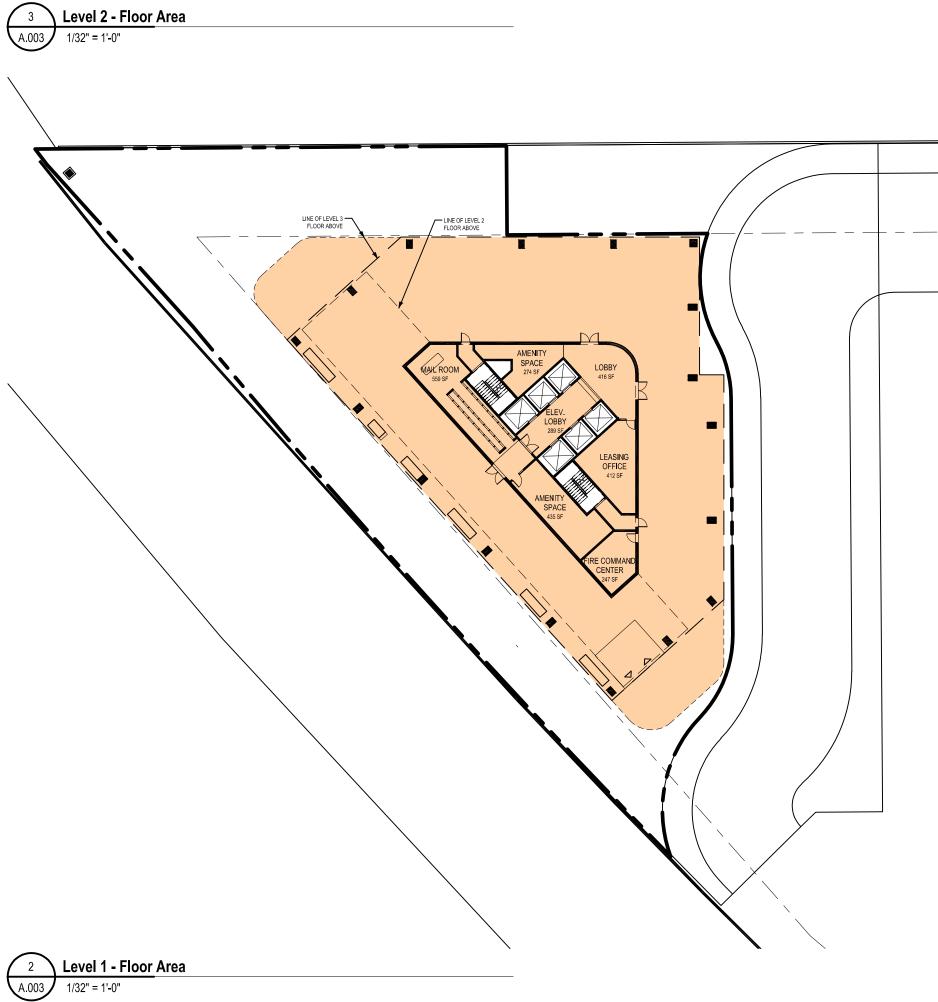

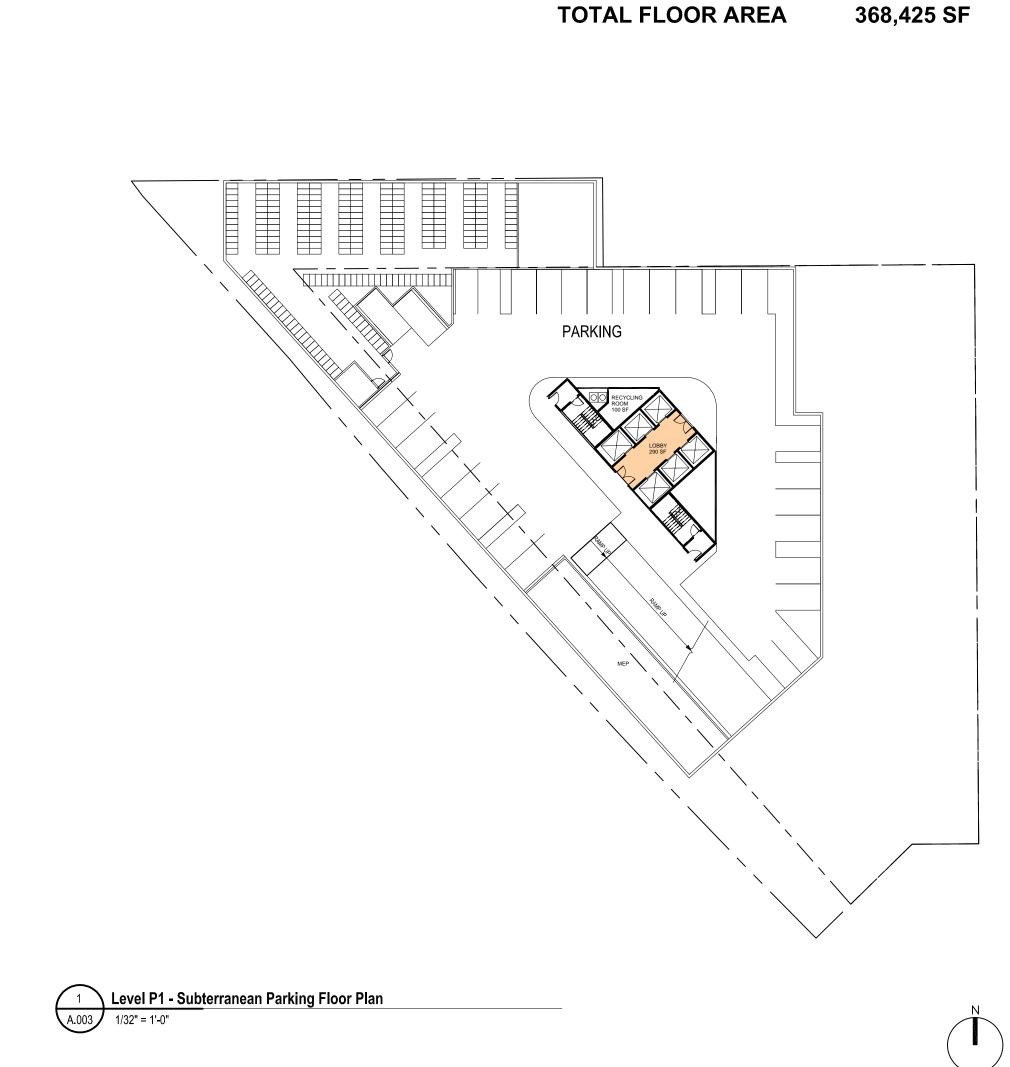




4 Level 3-25 Typical - Floor Area

1/32" = 1'-0"


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Level 26 Amenity/Mechanical Floor - Open Space Area

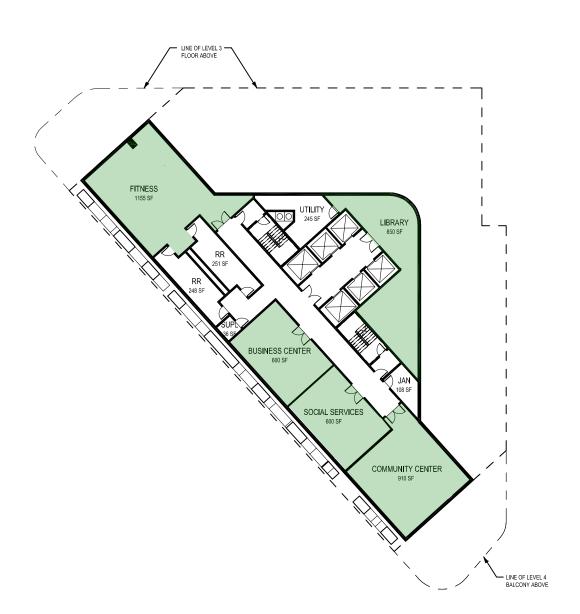1/32" = 1'-0"





**OPEN AREAS LEVEL** AREA **LOCATION** L1 Open Area PLAZA 10,815 SF 4,115 SF L2 Open Area **AMENITIES** 0 SF NORTH BALCONY L3 Open Area SOUTH BALCONY 0 SF L4 Open Area NORTH BALCONY 0 SF L5 Open Area **SOUTH BALCONY** 0 SF L6 Open Area 0 SF NORTH BALCONY L7 Open Area **SOUTH BALCONY** 0 SF L8 Open Area 0 SF NORTH BALCONY L9 Open Area 0 SF L10 Open Area **SOUTH BALCONY** 0 SF L11 Open Area NORTH BALCONY SOUTH BALCONY 0 SF L12 Open Area 0 SF L13 Open Area NORTH BALCONY 0 SF L14 Open Area SOUTH BALCONY NORTH BALCONY 0 SF L15 Open Area 0 SF L16 Open Area SOUTH BALCONY L17 Open Area NORTH BALCONY 0 SF 0 SF L18 Open Area SOUTH BALCONY 0 SF NORTH BALCONY L19 Open Area 0 SF L20 Open Area SOUTH BALCONY 0 SF L21 Open Area NORTH BALCONY 0 SF L22 Open Area SOUTH BALCONY 0 SF L23 Open Area NORTH BALCONY L24 Open Area SOUTH BALCONY 0 SF L25 Open Area NORTH BALCONY 0 SF L26 Open Area OUTDOOR TERRACE 10,195 SF

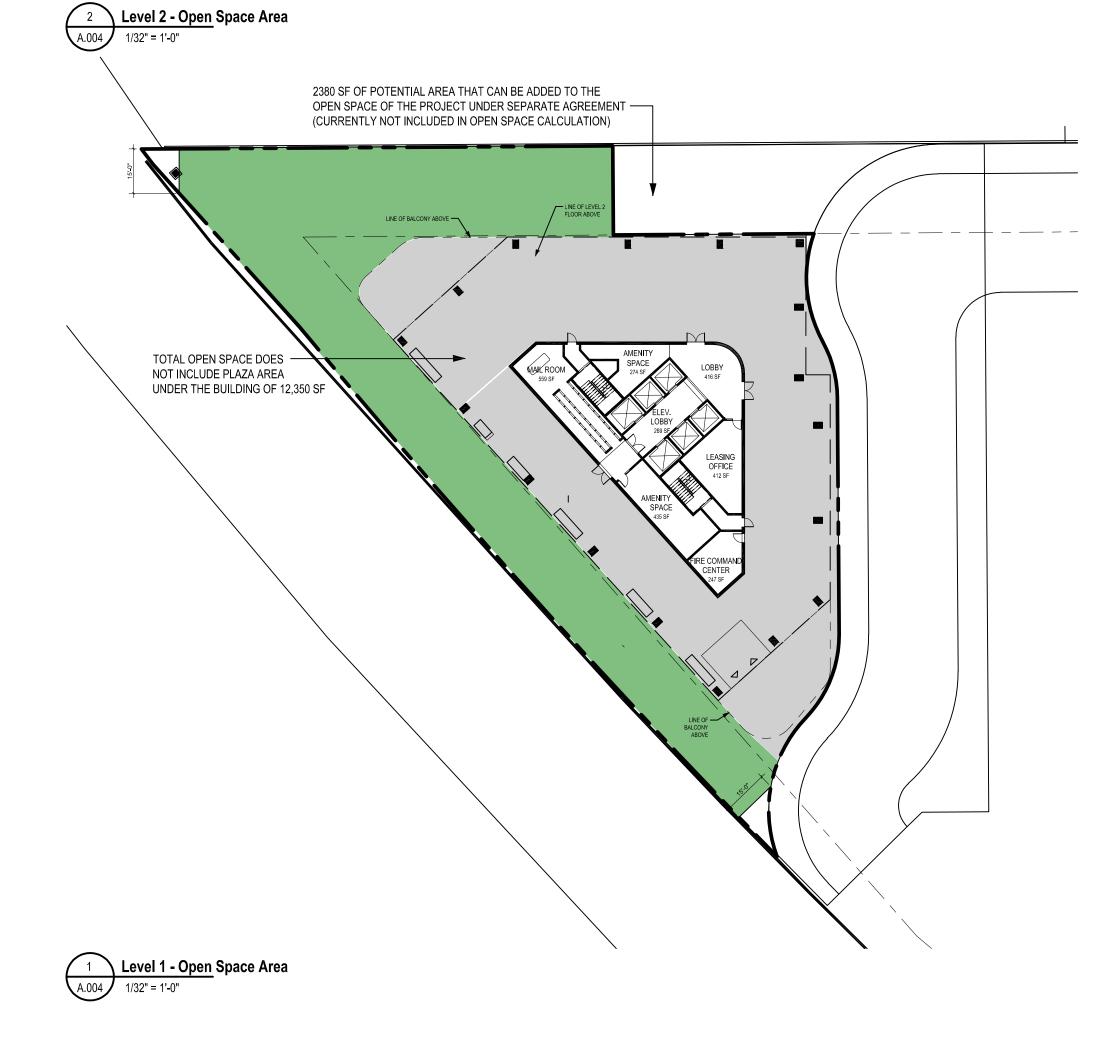**TOTAL OPEN SPACE: 25,125 SF** 

NOTE - TOTAL OPEN SPACE DOES NOT INCLUDE THE FOLLOWING:

12,350 SF OF OPEN PLAZA AMENITY AREA UNDER THE BUILDING

18,170 SF OF TOTAL BALCONY AREAS (ALTERNATING ON LEVELS 3-25)

2,380 SF OF POTENTIAL AREA ON THE NORTH EAST CORNER

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Open Space Area Plans

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**Current Revision** 

A004

**COLOR LEGEND** 


**OPEN SPACE** 



**OUTDOOR AMENITY SPACE NOT OPEN TO SKY** (NOT INCLUDED IN OPEN SPACE CACULATION)

3 Level 3-25 Typical Floor - Open Space Area
A.004 1/32" = 1'-0"

# 37'-10" MEP ROOM 725 SF 8'-6" PARKING 7 STANDARD + 20 COMPACT = 27 PARKING STALLS WITH STACKED PARKING: 54 STALLS (PARKPLUS DOUBLE STACKER: LARR #930501) (EL. -18'-0") (16' MINIMUM CLEAR CEILING HEIGHT) BIKE WORK SPACE 108 SF C 15'-0" 2 RIDESHARE PICKUP / DROP-OFF SPACES (NOT INCLUDED IN PARKING COUNT) MEP ROOM \

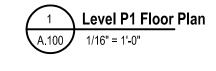

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Description

Project Information

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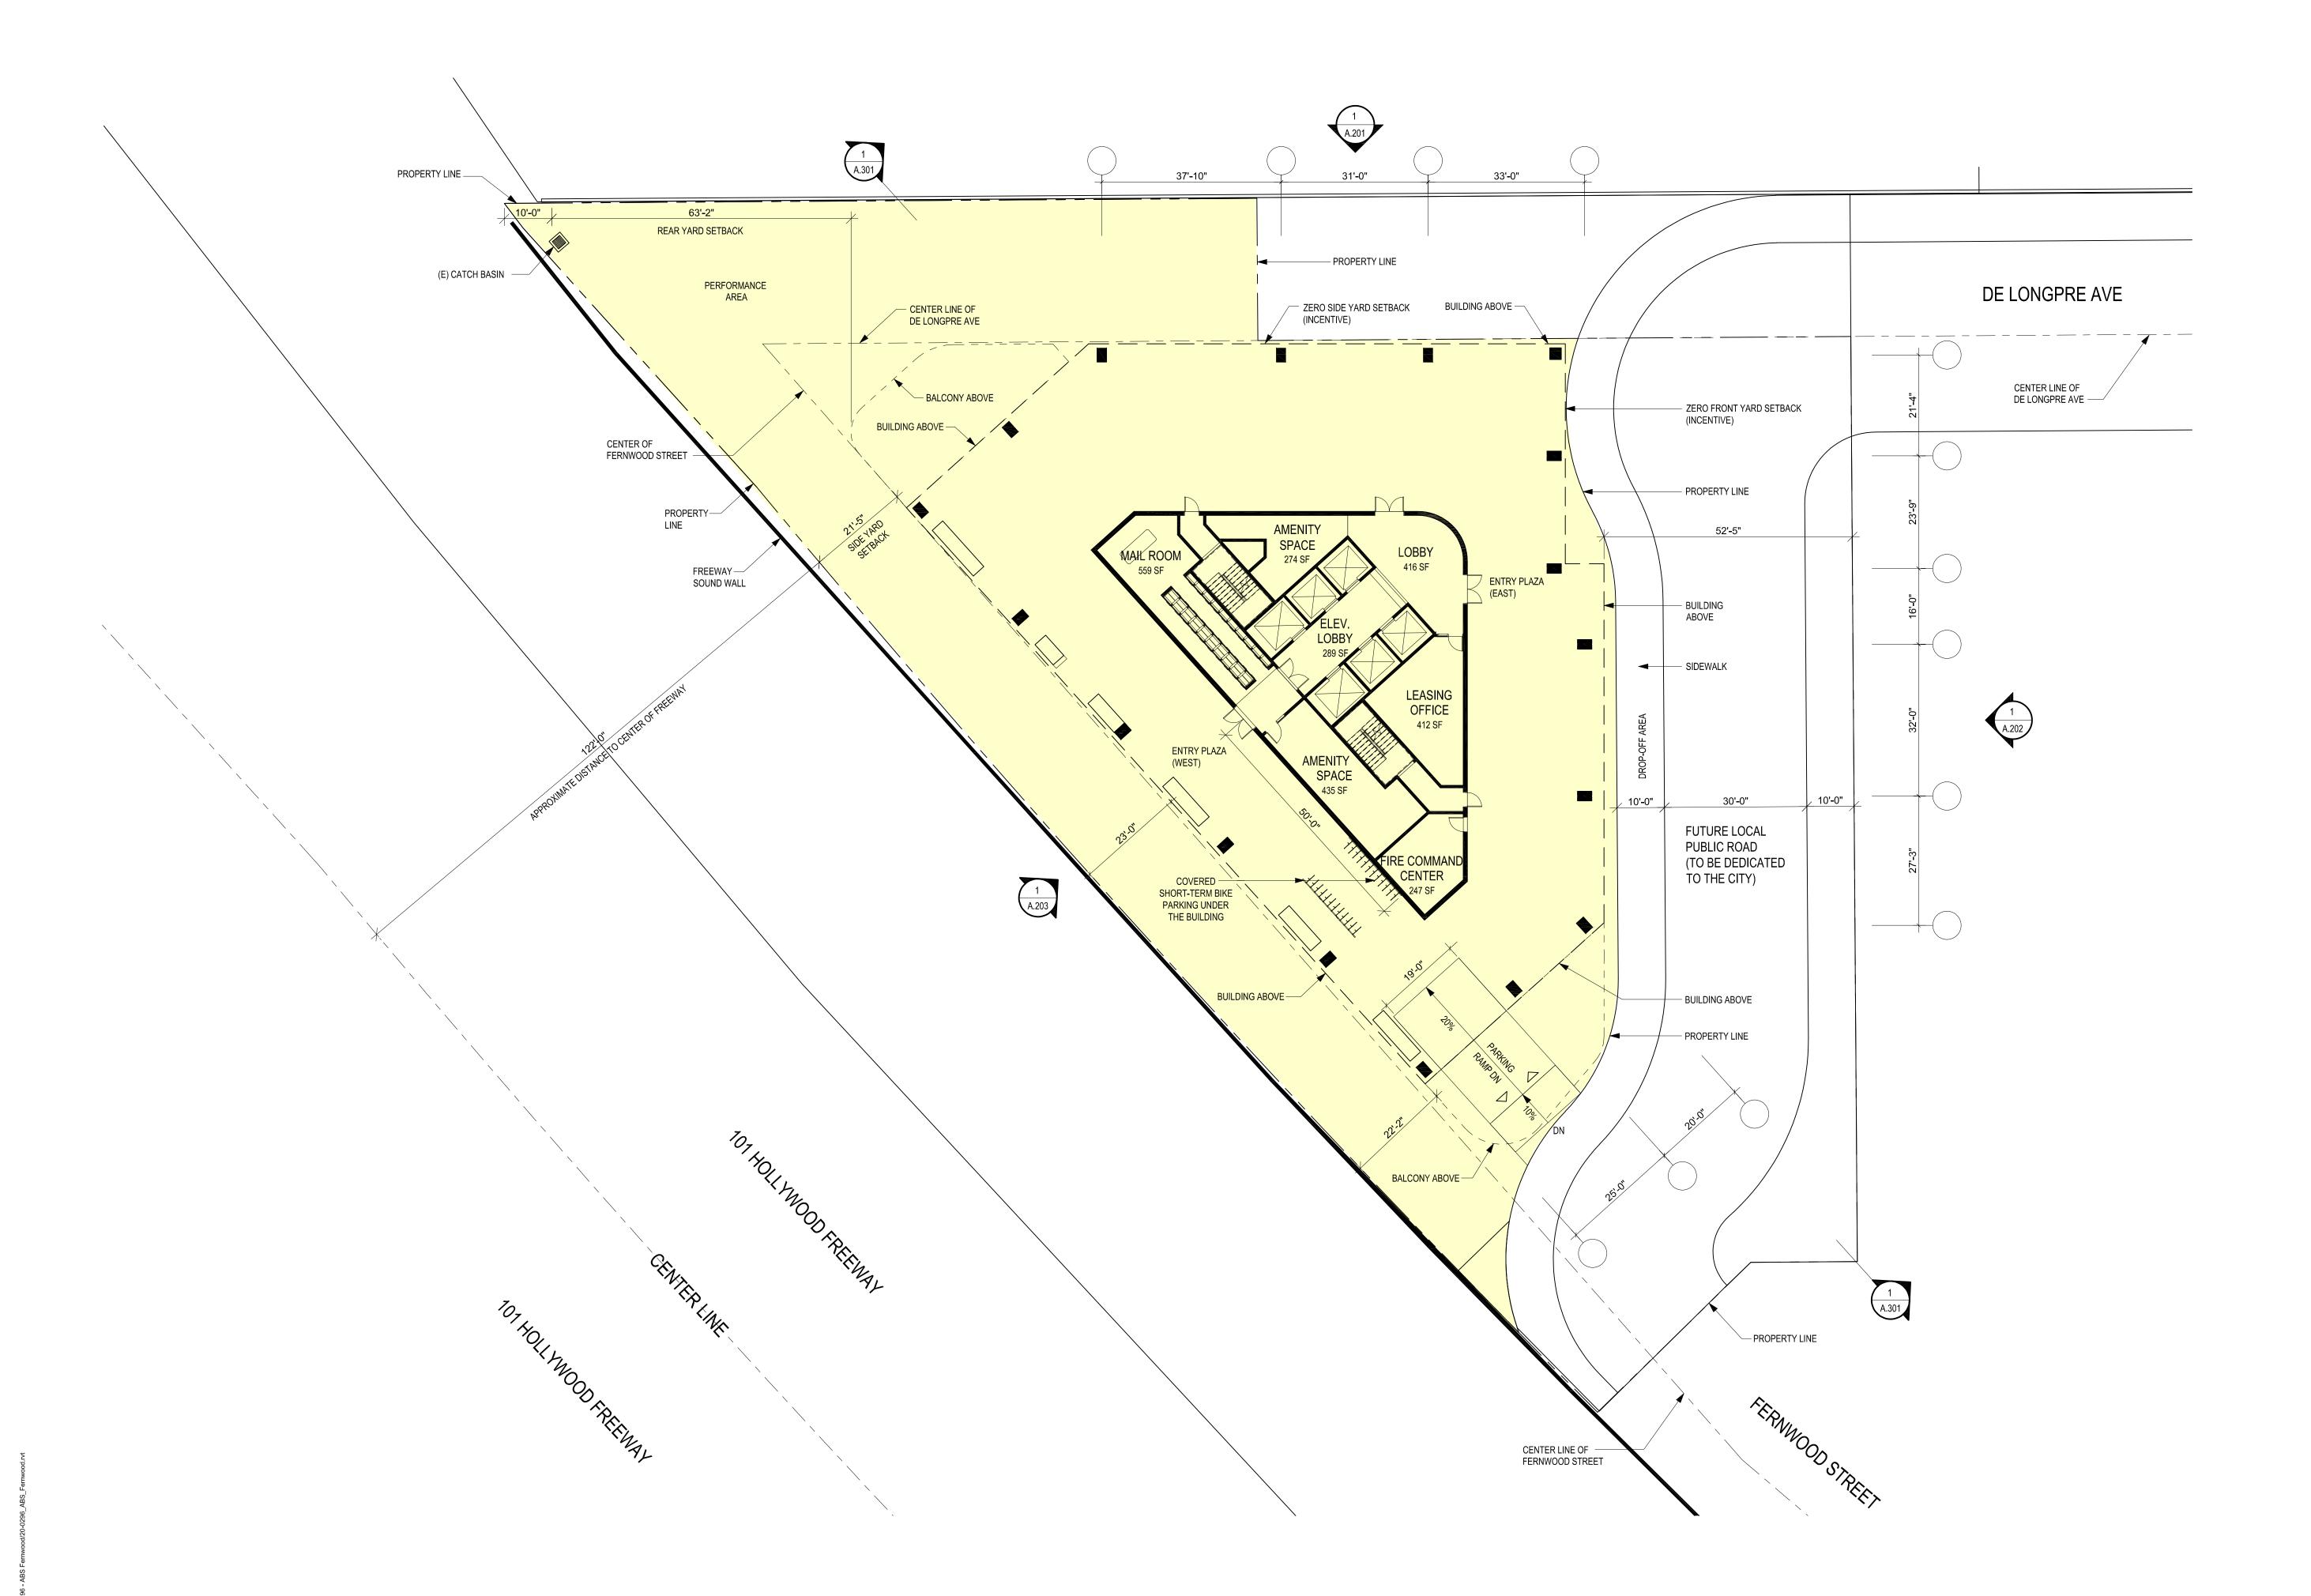
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Sheet Title

Level P1 Parking Floor Plan

**Current Revision** 

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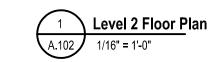
Sheet Title Level 1 Floor Plan

**Current Revision** 

A101

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# — BUILDING ABOVE BUSINESS CENTER 600 SF SOCIAL SERVICES 600 SF COMMUNITY CENTER 910 SF



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Description

Project Information

02/09/2021 Concept Design Date: 20-0296 PIC / AIC:

SkyVillage Hollywood

Sheet Title Level 2 Floor Plan


**Current Revision** 

A102

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UNIT SUMMARY	Levels 1-2	Levels 3-22	Levels 23 <b>-</b> 25	TOTAL (ALL FLOORS)	%
Studio Units	0	2x20	0	40	8
One Bedroom Units	0	20x20	52	452	91
Two Bedroom Units	0	0	6	6	1
Three Bedroom Units	0	0	1	1	0.002
Total:	0	440	59	499	100

Γ SUMMARY	Levels 1-2	Levels 3-22	Levels 23-25	TOTAL (ALL FLOORS)	%
Units	0	2x20	0	40	8
Bedroom Units	0	20x20	52	452	91
Bedroom Units	0	0	6	6	1
Bedroom Units	0	0	1	1	0.002
	0	440	59	499	100



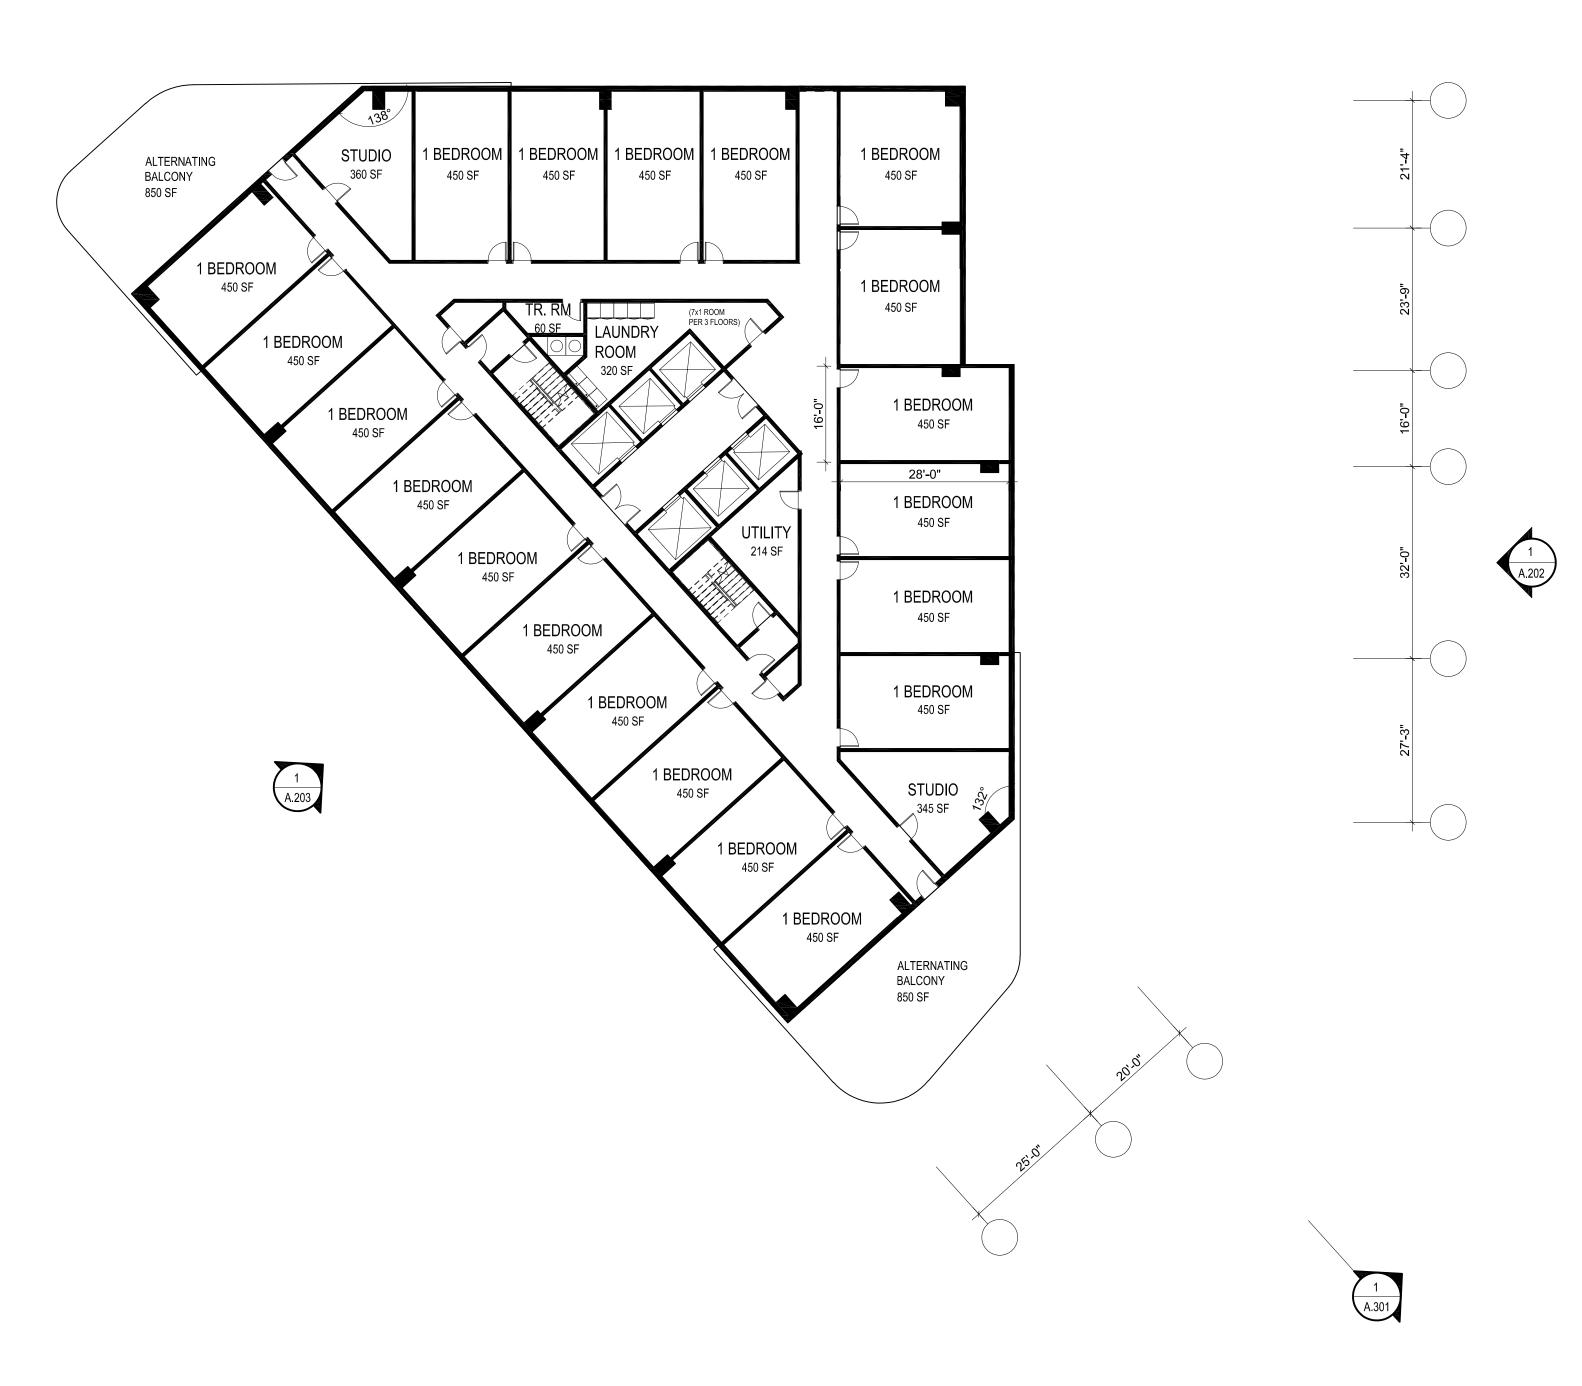

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Description

Project Information

Concept Design Date: 02/09/2021 20-0296 PIC / AIC:

SkyVillage Hollywood


Sheet Title
Level 3 - 22 Typical Floor Plan

**Current Revision** 

A103

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Description

Project Information

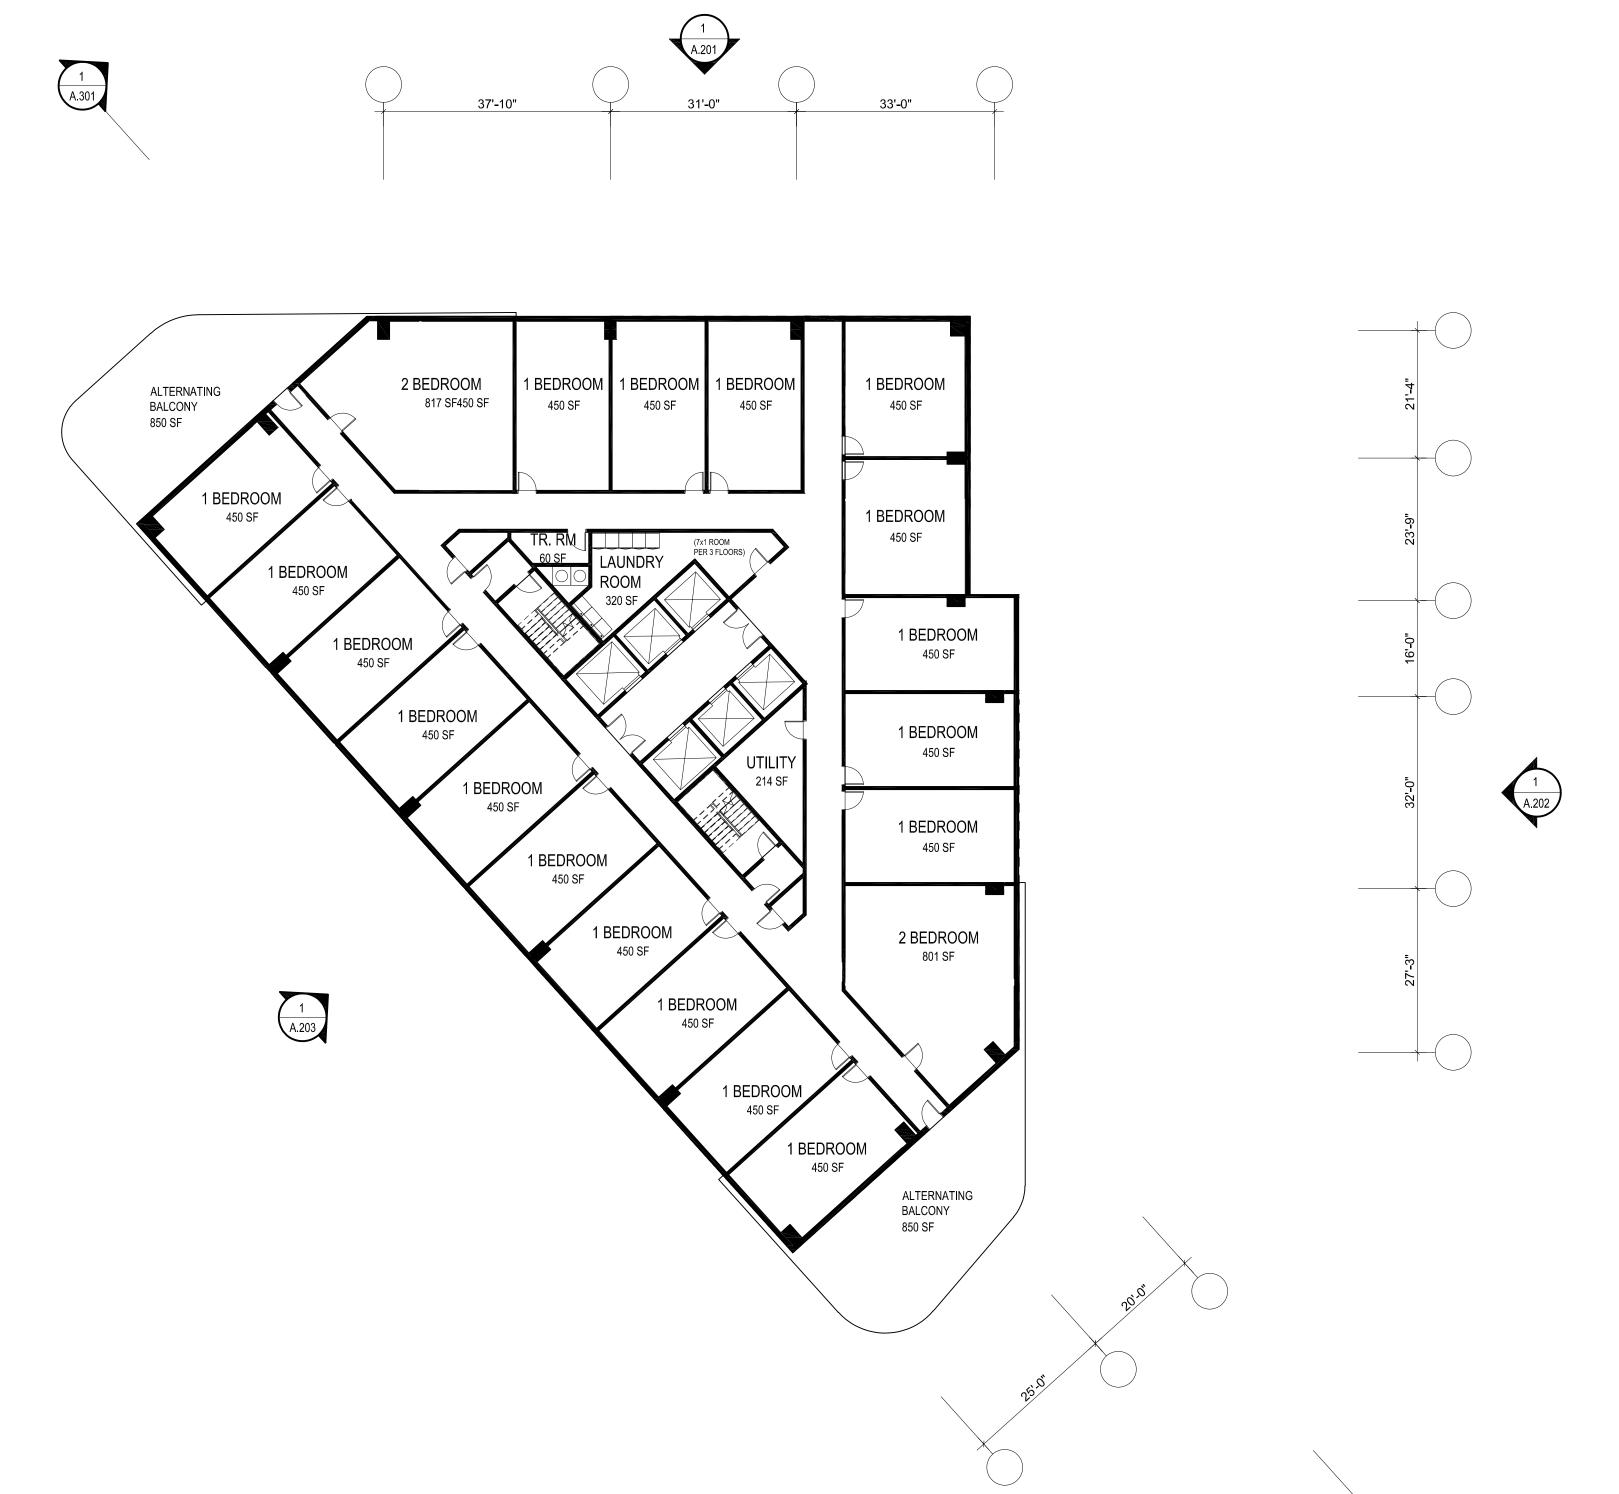Concept Design Date: 02/09/2021 20-0296 PIC / AIC:

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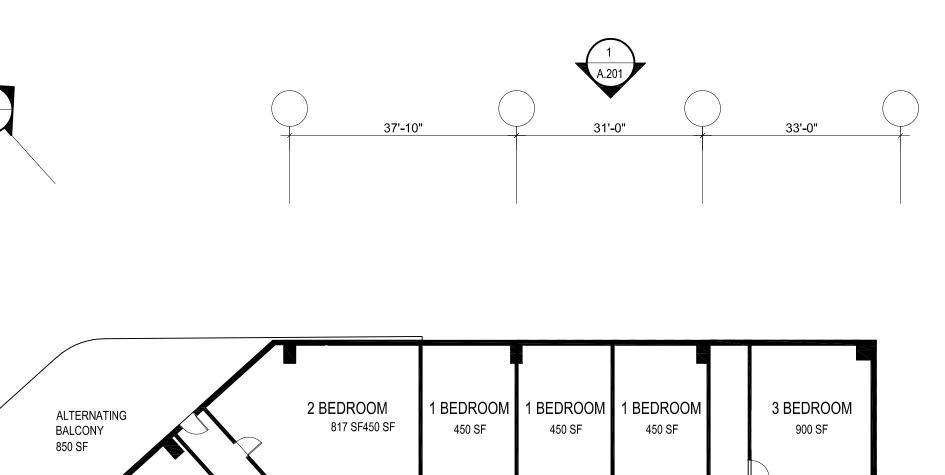
Sheet Title
Level 23-24 Typical Floor Plan

**Current Revision** 

A104

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Sheet Title Level 25 Floor Plan

**Current Revision** 

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1 Level 25 A.103 1/16" = 1'-0"

2 TYPICAL UNIT PLANS (FOR PURPOSE OF CALCULATING HABITABLE ROOMS FOR OPEN SPACE REQUIREMENTS)
A.106 1/16" = 1'-0"

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Description

**Project Information** 

Concept Design Date: 02/09/2021 20-0296 PIC / AIC:

SkyVillage Hollywood

Sheet Title
Amenity & Mechanical Level Floor Plan

**Current Revision** 

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<b>)</b> .	Date	

Project Information

 se:
 Concept Design
 Date:
 02/09/2021

 ect No.:
 20-0296
 PIC / AIC:

SkyVillage Hollywood

Sheet Title

Elevations

- FIBER CEMENT PANEL COLOR: BLACK OPAL 7020 BY SWISS PEARL OR SIM.

OFF-WHITE FIBER CEMENT PANEL
- COLOR: ONYX 7091 BY SWISS PEARL OR SIM.

Sheet Number

**Current Revision** 

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1 North
A.201 1/16" =

STOREFRONT WITH CLEAR GLASS -

Level 2 18' - 0"

Level 1 \_\_\_\_\_\_ EL. +350.42' (LOWEST POINT O

AMENITY ROOF DECK BEYOND (OPEN TO SKY) \_ METAL PANEL COLOR: NATURAL-ZINC BY VWZINC OR SIM. METAL PANEL COLOR: QUARTZ-ZINC BY VWZINC OR SIM. METAL PANEL Amenity/Mech COLOR: QUARTZ-ZINC BY VWZINC OR SIM. Level 25 256' - 8" Level 24 246' - 6" Level 23 236' - 4" Level 22 226' - 2" - BLACK FIBER CEMENT PANEL COLOR: BLACK OPAL 7025 BY SWISS PEARL OR SIM. Level 21 216' - 0" OFF-WHITE FIBER CEMENT PANEL COLOR: ONYX 7091 BY SWISS PEARL OR SIM. Level 20 205' - 10" Level 19 195' - 8" - PERFORATED METAL PANEL - COLOR MATCH OFF-WHITE FIBER CEMENT Level 18 185' - 6" Level 17 175' - 4" Level 16 165' - 2" Level 15 155' - 0" - VEGETATION SCREEN PLANTERS Level 14 144' - 10" Level 13 134' - 8" Level 12 124' - 6" - WOOD LOOK METAL PANEL (ALL SOFFITS) COLOR: LIGHT FIR BY LONGBOARD OR SIM. Level 11 114' - 4" Level 10 104' - 2" Level 9
94' - 0" Level 8 83' - 10" Level 7
73' - 8" Level 6
63' - 6" Level 5
53' - 4" Level 4 43' - 2" METAL PANEL COLOR: NATURAL-ZINC BY VWZINC OR SIM. - WOOD LOOK METAL PANEL (ALL SOFFITS) COLOR: LIGHT FIR BY LONGBOARD OR SIM. METAL PANEL COLOR: QUARTZ-ZINC BY VWZINC OR SIM.

upufoujuno

NOT FOR CONSTRUCTION

SkyVillage Hollywood


Sheet Title Elevations

1 11		<i>ω</i> ι —	ωı
	WOOD LOOK METAL PANEL (ALL SOFFITS) COLOR: LIGHT FIR BY LONGBOARD OR SIM. FIBER CEMENT PANEL COLOR: BLACK OPAL 7020 BY SWISS PEARL OR SIM.	OFF-WHITE FIBER CEMENT PANEL COLOR: ONYX 7091 BY SWISS PEARL OR SIM. EL. +350.42' (LOWEST POINT OF PROPERTY)	

WOOD LOOK METAL PANEL COLOR: LIGHT FIR BY LONGBOARD OR SIM.

STOREFRONT WITH CLEAR GLASS

MA 70:33:9 1202/01\2

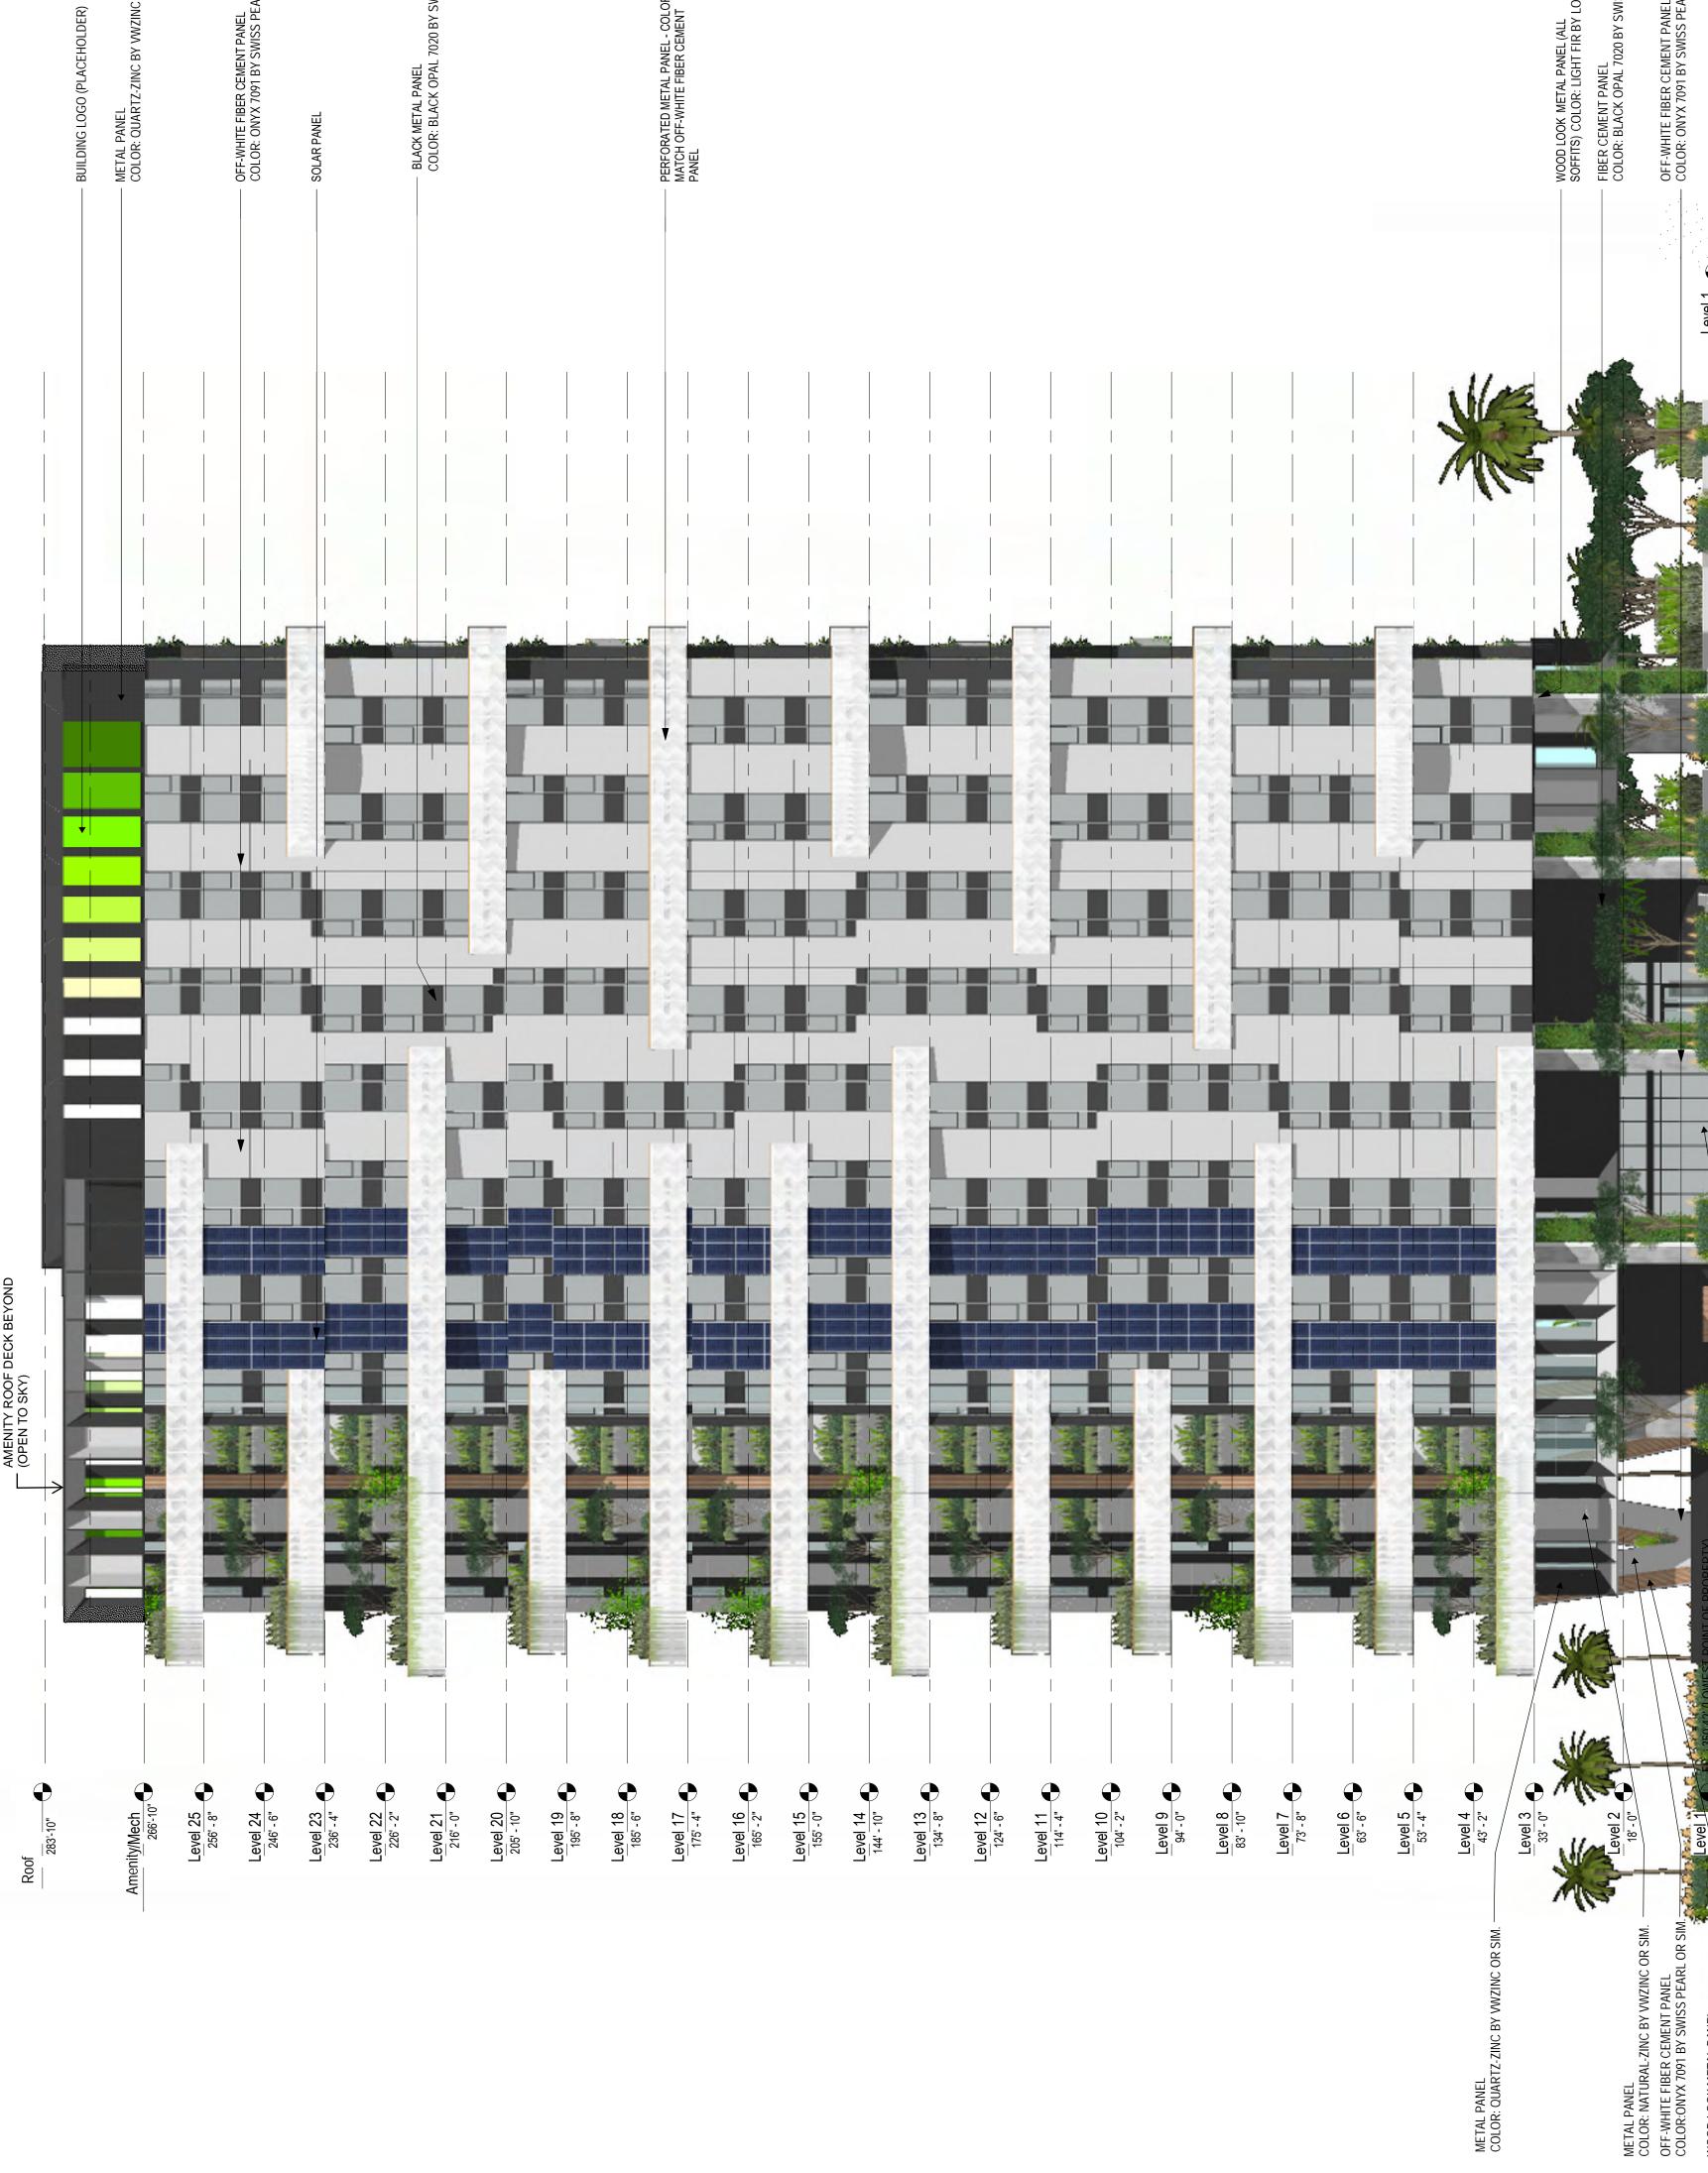



NOT FOR CONSTRUCTION

Revisions

No. Date Description

**Project Information** 

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Concept Design Date:

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Elevations

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**Current Revision** 

02/09/2021

4 203

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# NOT FOR CONSTRUCTION

Description


Concept Design Date: 20-0296 PIC / AIC:

SkyVillage Hollywood

Sheet Title Sections

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A 301

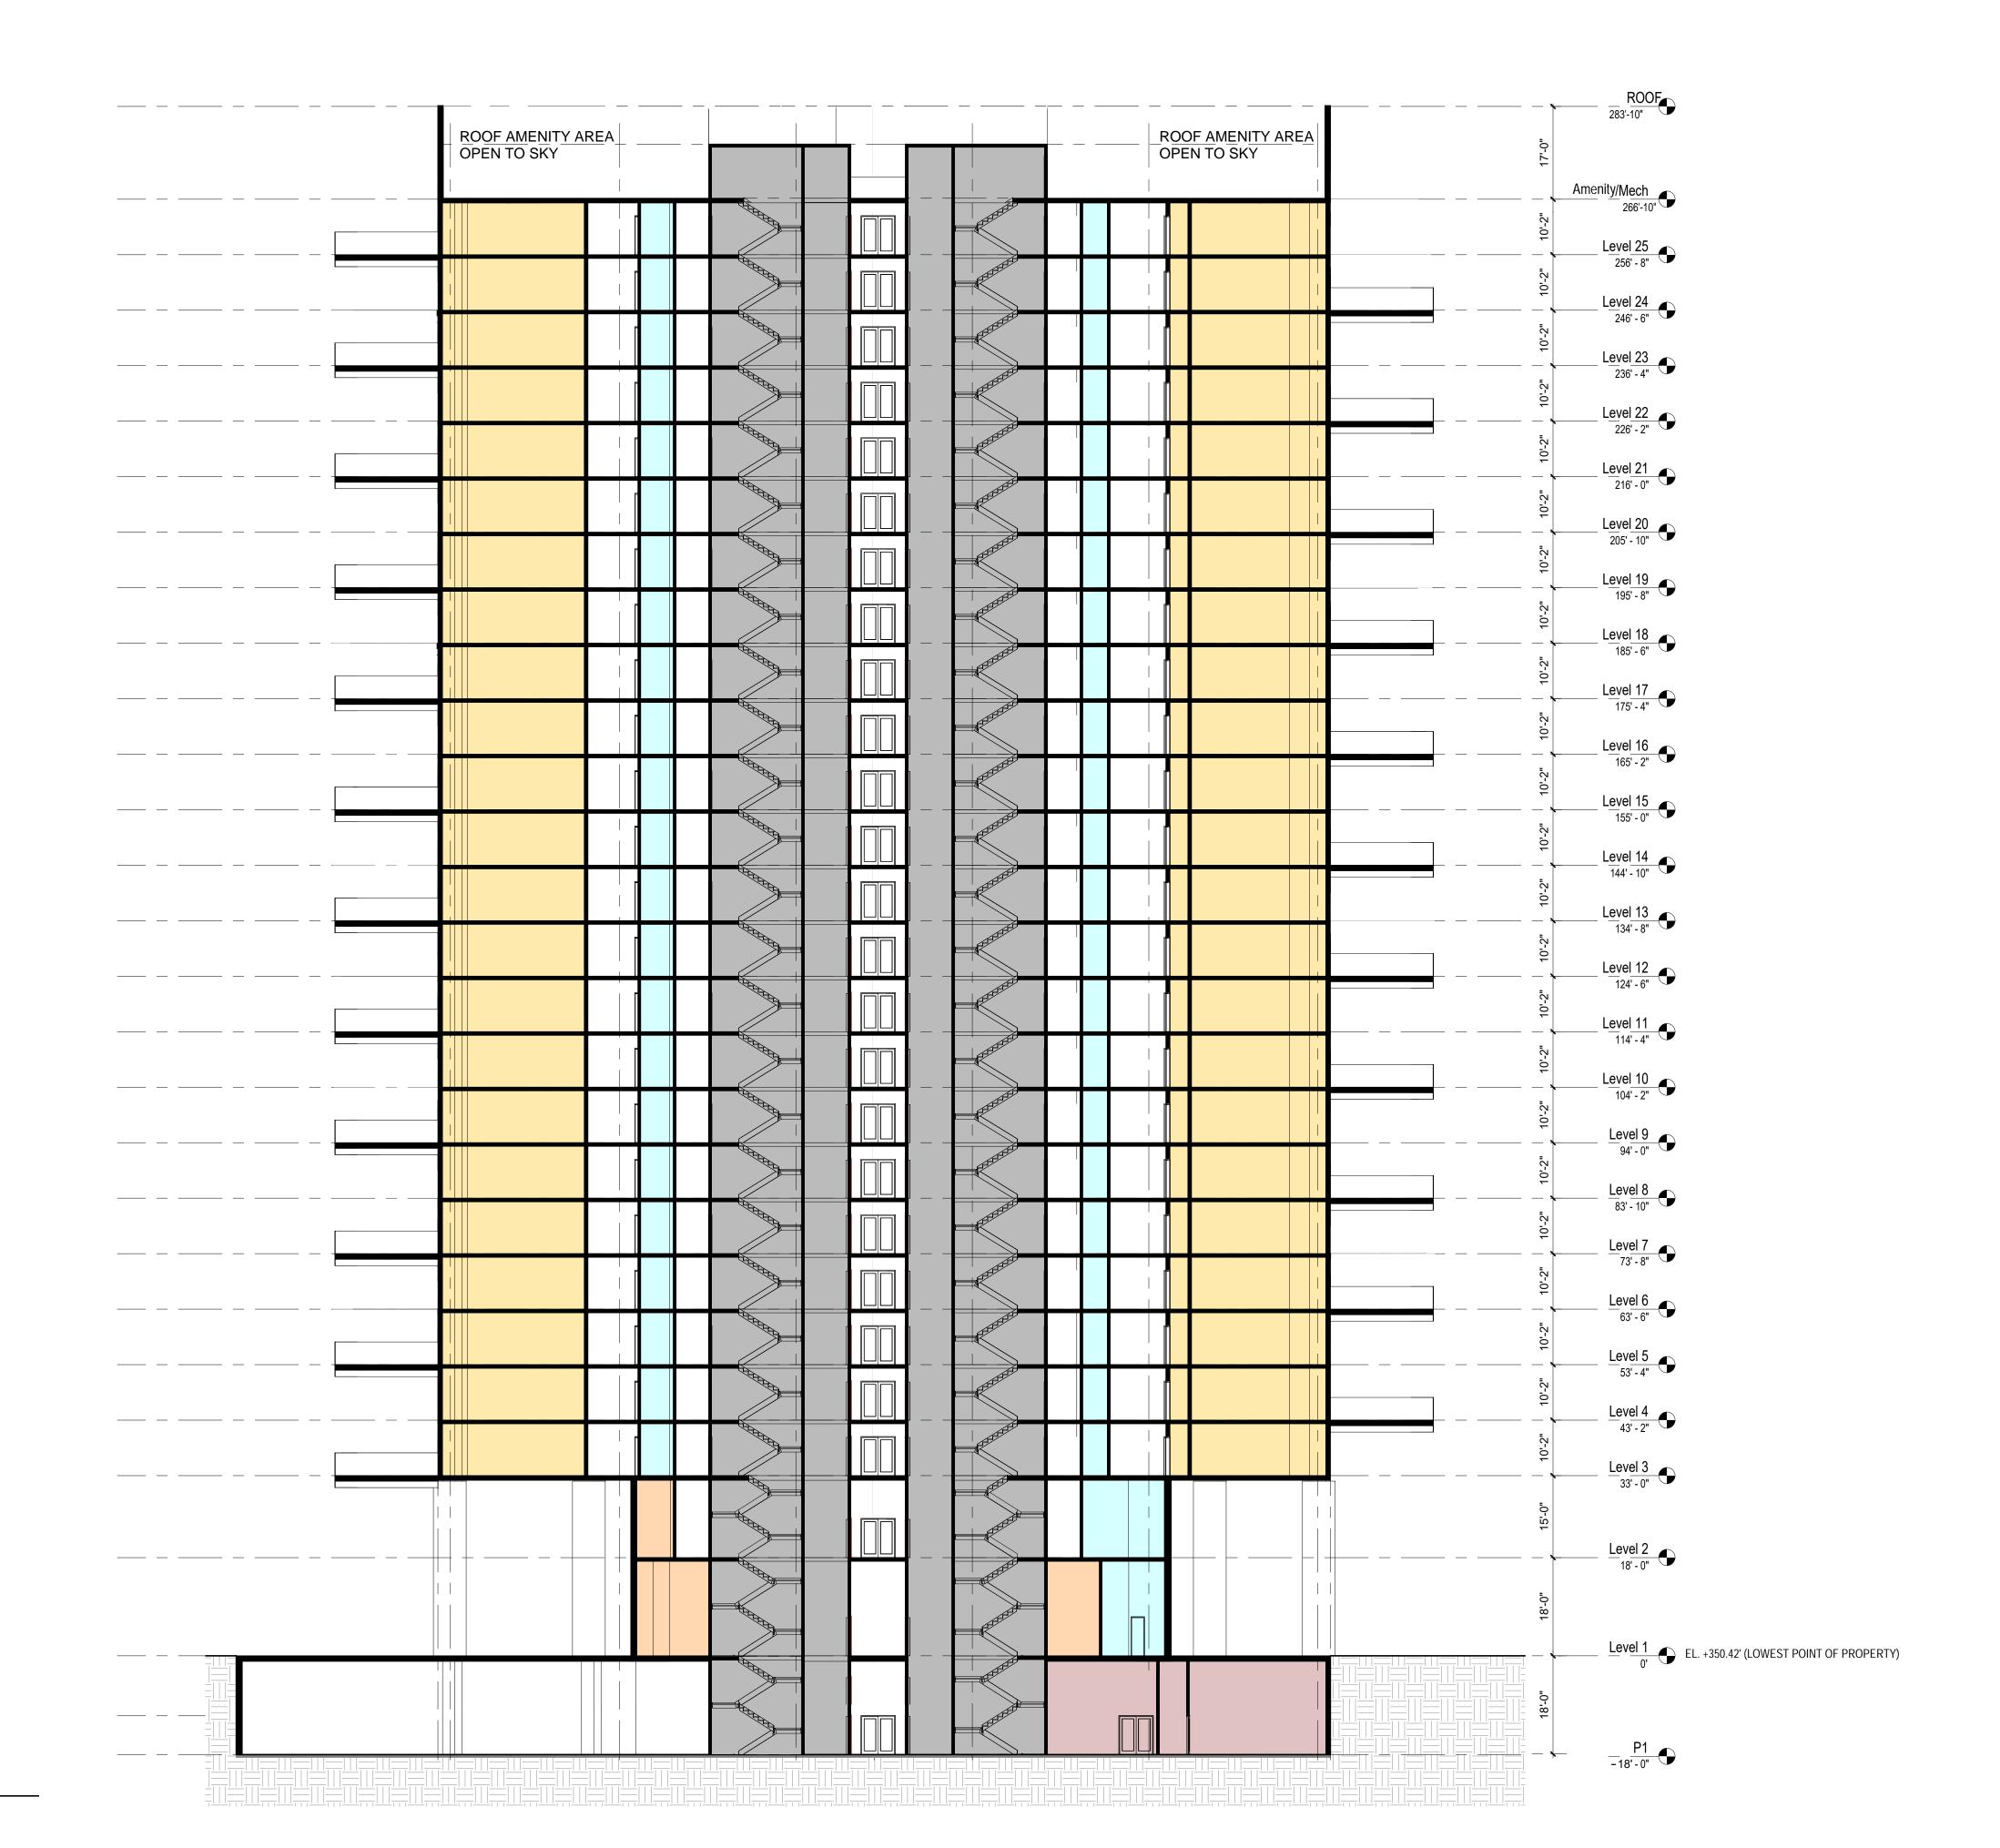

#### OFFICE OF ZONING ADMINISTRATION

200 N. SPRING STREET, ROOM 763 LOS ANGELES, CA 90012-4801 (213) 978-1318

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CHIEF ZONING ADMINISTRATOR

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CHRISTINA TOY LEE

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CALIFORNIA



LOS ANGELES DEPARTMENT
OF CITY PLANNING
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SHANA M.M. BONSTIN
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ARTHI L. VARMA, AICP DEPUTY DIRECTOR

LISA M. WEBBER, AICP DEPUTY DIRECTOR planning.lacity.org

#### **Filing Notification and Distribution**

DATE OF FILING AND MAP STAMP ADDRESS: 5645 W FERNWOOD AVE. DATE: 07/7/2022 **COMMUNITY PLAN Hollywood** VTT- MAP NO: VTT-82118-CN-VHCA **EXPEDITED** ENV-2022-4851-EAF **DEEMED COMPLETE AND DISTRIBUTION** PROCESSING SECTION DATE: 08/04/2022 Hillside: ()Yes (X) No (X) COUNCIL DISTRICT NO: 13 ( ) Community Plan Revision ( ) Neighborhood Planning (Check Office below) (X) Department of Recreation and Parks (X) Bureau of Street Services- Urban Forestry (X) Valley West Los Angeles (X) Bureau of Street Lighting (No. P.S.) ( ) Animal Regulation (Hillside) Harbor (X) Housing Department Metro E/S (X) Board of Education (No P.S.) Department of Public Works (X) Los Angeles County Health Department Bureau of Engineering (X) (X)Bureau of Sanitation (No P.S.) Department of Building and Safety ( ) City of Beverly Hills **Grading Engineer** (See Counter Map) (No P.S.) (**X**) (X) Valley DOT - Taghi Gharagozli (X) Zoning Engineer (X) Department of Transportation (X) Imaging Services Department of Water and Power (X) GIS - c/o Fae Tsukamoto **Underground Design** (X): Hollywood Studio District Neighborhood Real Estate Council (X)N.C. please respond with comments within 90 days (X)Water System from "deemed complete and distribution date" Fire Department (mark "Fire") (X)(LISTED ABOVE).

The above tract has been filed with City Planning, Expedited Processing Section.

The assigned planner for this case will await your report and recommendation regarding the above matter for 39 days. If we have not received a written report from you after 40 days from the date of filing, we will assume that you have no report to make.

Vincent P. Bertoni, Director of Planning

#### Brenda Kahinju


For:

Heather Bleemers, Senior City Planner Expedited Processing Section CP-6300 (1/21/09)

# RECOMMENDATION REPORTS DUE BY: 9/13/2022


Please forward reports to the following e-mail address:


planning.expedited@lacity.org

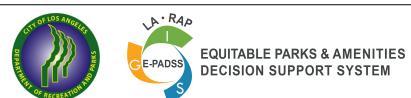

#### E-PADSS Map Output




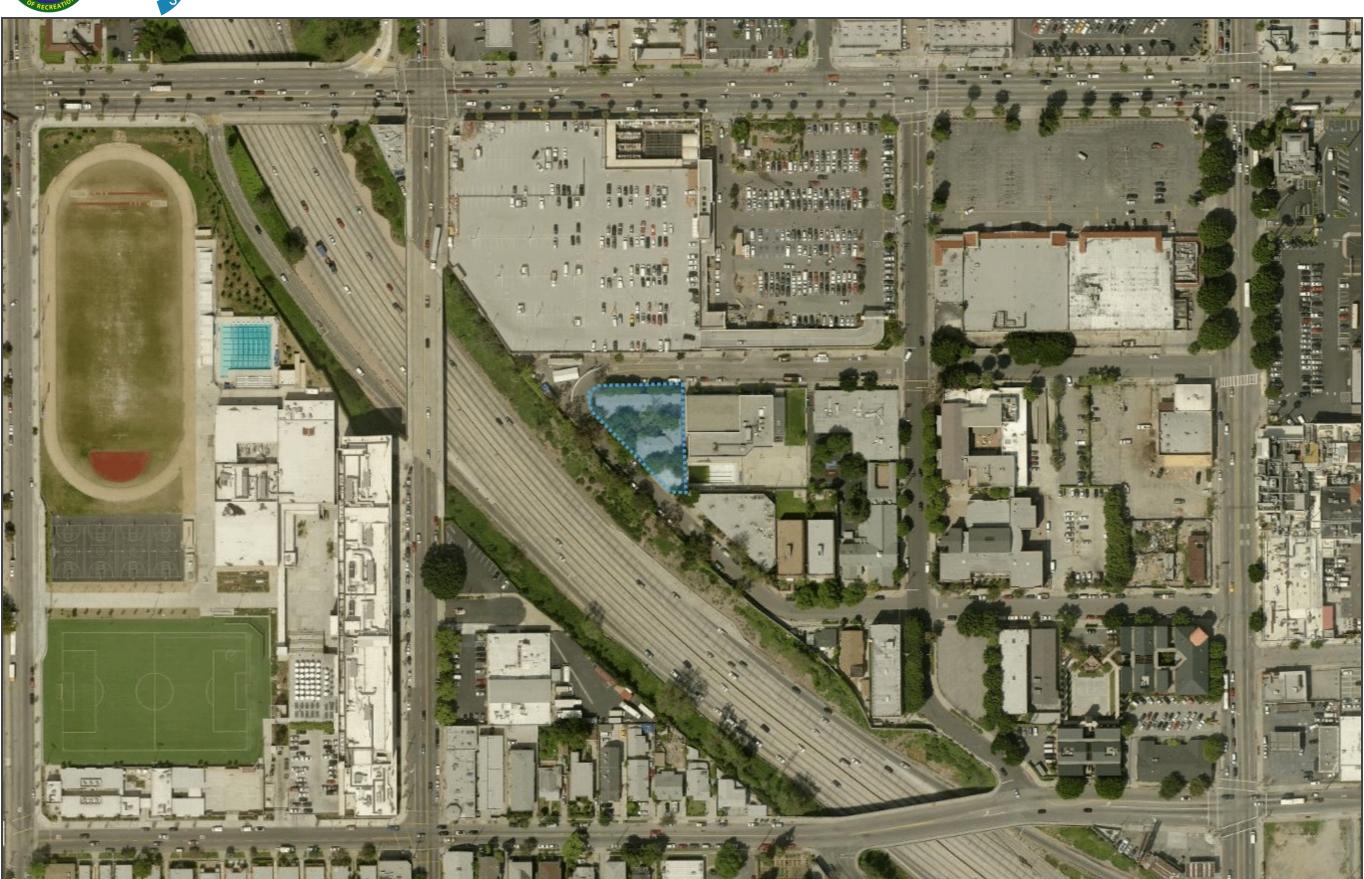

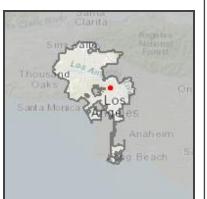

LEGEND


NOTES

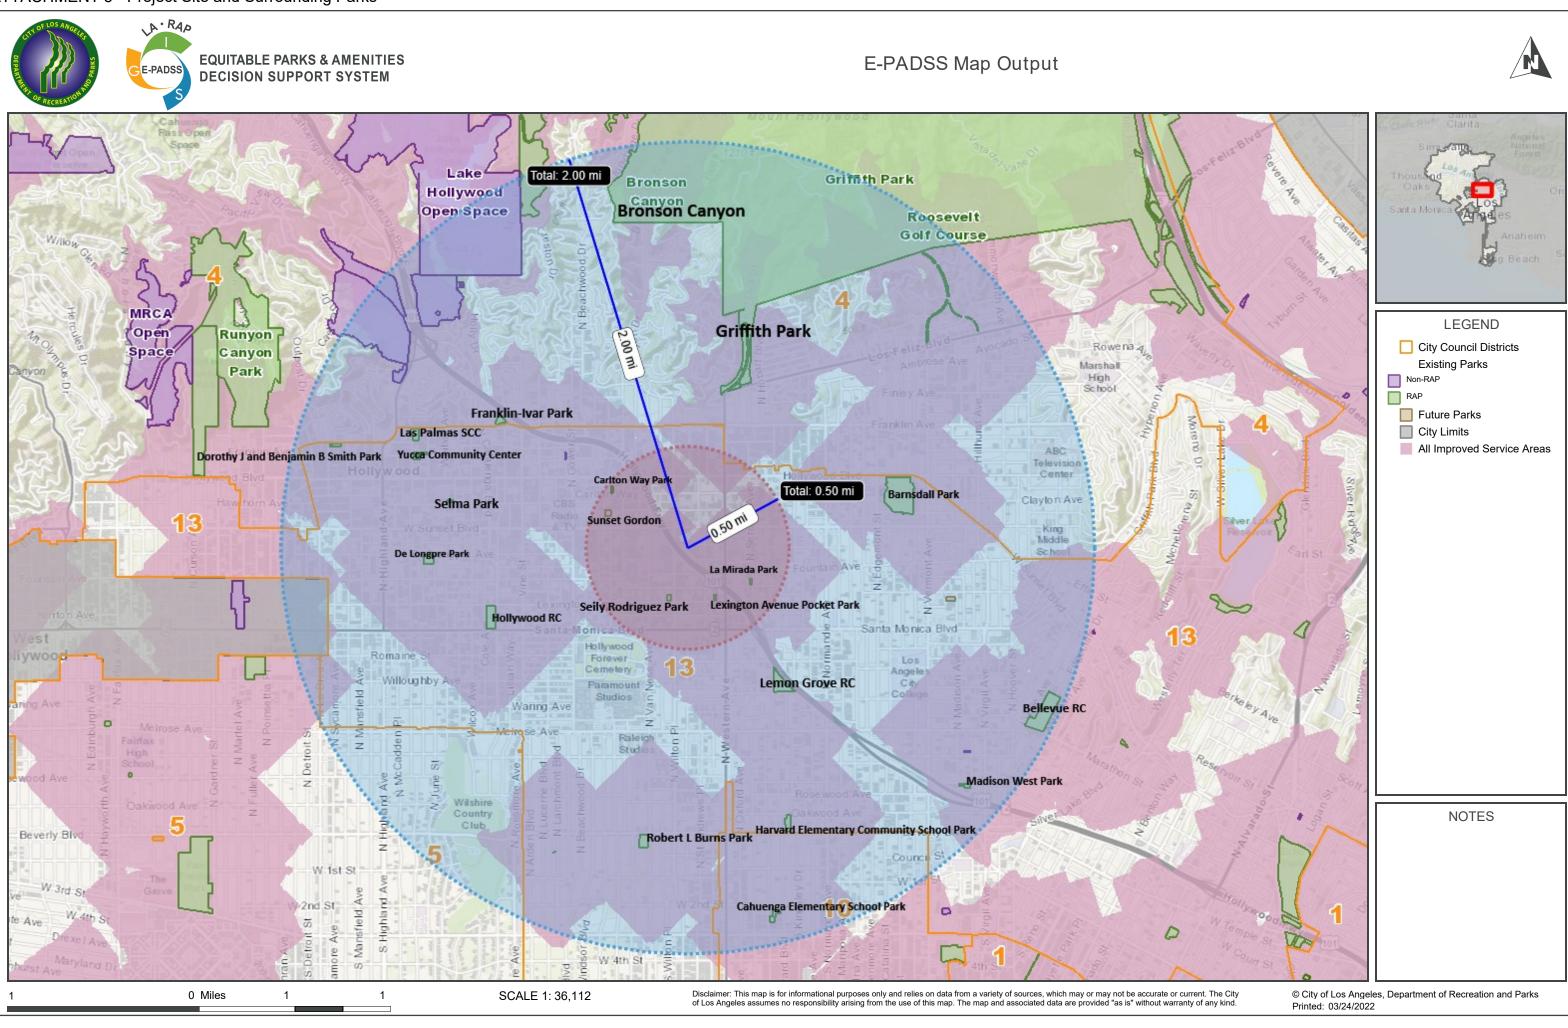





#### **Park Analysis Report**

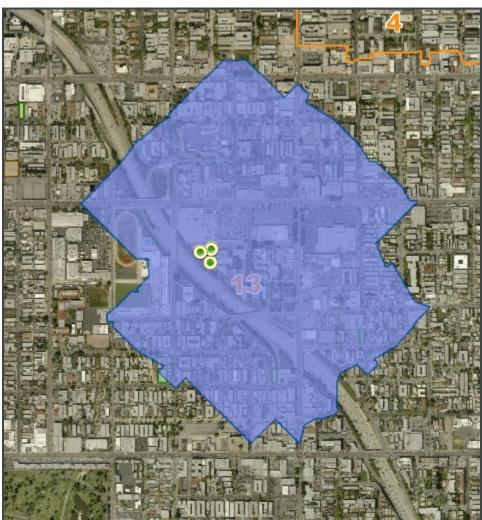

#### **Scenario Information**

Scenario Name:

VTT-82118

Description:

26-story affordable apartment building with 499 units (includes 5 managers units)

Scenario Type:

New Park

Park Class:

Neighborhood

Baseline Dataset\*:

All Parks (RAP and Non-RAP)

\*The baseline dataset is the existing parks dataset whose service areas are used to calculate the currently non-served metrics given below in blue. These residents and households, which would be served by the proposed park, are not currently served by any existing park in the baseline dataset.

#### **Population and Age Breakdown**

#### **Household and Income Breakdown**

Residents Served: 7,362 2,584 Households Served: 2,483 979

Residents Served by Age			Households Served by Annual Income		
Under Age 5:	417	137	Under \$25,000:	919	436
Age 5 to 9:	357	128	\$25,000 to \$34,999:	390	163
Age 10 to 14:	409	153	\$35,000 to \$49,999:	434	105
Age 15 to 17:	313	108	\$50,000 to \$74,999:	434	115
Age 18 to 64:	5,251	1,890	\$75,000 and Over:	306	160
Age 65 and Over:	615	168		Source	e: Census/ACS 2010