BOARD OF RECREATION AND PARK COMMISSIONERS

JUL 17 2019

BOARD REPORT

NO. 19-142

DATE July 17, 2019

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BOARD OF RECREATION AND PARK COMMISSIONERS

SUBJECT: CYPRESS RECREATION CENTER – PRELIMINARY CONCEPTUAL APPROVAL FOR THE INSTALLATION OF CELLULAR EQUIPMENT BY T-MOBILE WEST, LLC.

AP Diaz		S. Piña-Cortez				
H. Fujita	1	C. Santo Domi	ingo_ D			
V. Israel		* N. Williams				
				Ding Gener	/ Jon ral Manager	
Approved	X		Disapproved		Withdrawn	

RECOMMENDATIONS

- 1. Grant preliminary conceptual approval for the installation of cellular communication equipment by T-Mobile West, LLC (T-Mobile) at Cypress Recreation Center in accordance with the details set forth in this Report and its Exhibits (Project); and
- 2. Authorize the Department of Recreation and Parks (RAP) General Manager, or designee, to issue the necessary Right-of-Entry (ROE) permits and execute permit applications as may be required for T-Mobile to complete necessary testing and obtain necessary entitlements for the Project; and
- 3. Direct RAP staff to return to the Board of Recreation and Park Commissioners for approval of a final Site Lease Agreement (SLA) upon completion of all preliminary activities for the Project as described in this Report, determination of environmental impacts of the Project, and finalization of material terms for the SLA.

SUMMARY

On May 4, 2011, the Board of Recreation and Park Commissioners (Board) approved Report No. 11-119 which authorized RAP to enter into a Master Lease Agreement (MLA) with cellular telecommunication providers for the purpose of facilitating the review of individual Site Lease Agreements (SLA), each of which will be reviewed for approval by the Board. On October 17, 2018, the Board approved Report No. 18-219, which authorized RAP to enter into an MLA for the installation of cellular equipment with T-Mobile West, LLC (T-Mobile).

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T-Mobile has submitted a request for an SLA to install cellular equipment at Cypress Recreation Center under the terms of the MLA. Cypress Recreation Center is located at 2630 E. Pepper Avenue. This is a 3.49acre facility which features a recreation center, multi-purpose sports field with lighted ball diamond, children's play area, and offers a variety of sports and other programs.

The proposed installation would include an antennae array located on a field light-pole adjacent to the sports field and an equipment enclosure located to the rear of the recreation center. The existing light-pole is approximately 75' tall and would be replaced with a similar structure. The ground located equipment shelter would be approximately 8' tall. The 10'x15' equipment shelter will be finished with a stucco exterior and be painted in a manner similar to recreation center in order to minimize visual impact. The enclosure will contain the required computer equipment, and emergency generator to effectuate the cellular site. Photo renderings of the existing conditions and proposed installations are attached hereto as Exhibit A. Site Plan and Elevations are attached hereto as Exhibit B.

RAP staff conducted an initial project walk-through with the applicant. RAP staff included representatives from Planning, Landscape Architecture, Maintenance and Recreation staff in order to identify any potential disruption that the project may cause to the location. At the walk-through it was determined that existing storage containers on site will need to be rotated ninety degrees (90°) at applicants' sole expense. RAP staff finds that utilization of a light-pole in lieu of adding any new structure to be the alternative which is the least visually intrusive and which retains the maximum amount of existing open space.

Should the Board grant conceptual approval for this project the next steps would be for RAP to issue the appropriate ROE permits in order for the applicant to complete necessary testing as well as granting staff authorization to sign permit applications for the applicant to apply for other necessary entitlements. RAP staff will also ensure a community input process including, at a minimum, discussion of this topic at a Park Advisory Board meeting, a Neighborhood Council meeting, and one publicly noticed (500-foot radius) RAP meeting in reference to this proposal. If and when all necessary entitlements and permits have been obtained RAP staff will return to the Board for a final consideration of a SLA. A summary of the community outreach will be included in that future Board Report.

RAP staff supports the recommendations contained in this Report.

TREES AND SHADE

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The project, as proposed, does not involve the removal or trimming of any trees and therefore there is no anticipated impact to trees or shade.

ENVIRONMENTAL IMPACT

It is the intent of RAP to integrate the planning and decision-making processes for this application with the evaluation of potential environmental effects as required by the California Environmental Quality Act (CEQA) and the associated City and State CEQA Guidelines. The required environmental review will be conducted prior to any final approval of any SLA, and RAP staff will present the Board with CEQA determinations when it returns to the Board for final approval of an SLA for this project.

FISCAL IMPACT

The conceptual approval of this project will not have an impact on RAP's General Fund as all application and eventual construction costs are the responsibility of the applicant. The initial SLA application fee of \$2,000 is sufficient to cover the expense for RAP staff to process this application. Should the application for a lease be granted in Fiscal Year 2019-2020 the initial annual fee for this location would be \$33,896. Subsequent increases in rent will be based on either the Consumer Price Index or a fixed percentage as detailed in the MLA.

STRATEGIC PLAN INITIATIVES AND GOALS

Approval of this Board Report advances RAP's Strategic Plan by supporting:

Goal No. 2: Provide Safe and Accessible Parks

Outcome No. 2: Safe and welcoming environments at all parks

Metric D: Install security cameras and other safety technology at parks based on needs identified by RAP staff, community members, law enforcement, and other park stakeholders.

Result: Access to a robust cellular network will provide additional safety to park patrons.

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This Report was prepared by Melinda Gejer, City Planning Associate, Planning, Maintenance and Construction Branch.

LIST OF ATTACHMENTS/EXHIBITS

- Exhibit A Photo Renderings of the proposal
 Exhibit B Site Plan and Elevations

T - Mobile

SV13736A LA CITY CYPRESS REC CENTER

2630 PEPPER AVENUE LOS ANGELES CA 90065







T - Mobile

SV13736A LA CITY CYPRESS REC CENTER

2630 PEPPER AVENUE LOS ANGELES CA 90065





VIEW 2

T - Mobile

SV13736A LA CITY CYPRESS REC CENTER

2630 PEPPER AVENUE LOS ANGELES CA 90065





VIEW 3

SITE NUMBER: SV13736A LA CITY CYPRESS REC CENTER SITE NAME: SITE TYPE: LIGHT STANDARD

SAC REP.

FOP REP.


ZONING DRAWING SHEET INDEX: IF USING 11"X17" PLOT, DRAWINGS WILL BE HALF SCALE SHEET: **DESCRIPTION: PROJECT SUMMARY:** SITE ADDRESS: T — 1 TITLE SHEET 2630 PEPPER AVE. LOS ANGELES, CA 90065 LS-1 TOPOGRAPHIC SURVEY LS-2 TOPOGRAPHIC SURVEY PROPERTY OWNER: ADDRESS: 2630 PEPPER AVE. A-1 SITE PLAN LOS ANGELES, CA 90065 LA CITY CYPRESS RECREATION CENTER CONTACT: ENLARGED SITE PLAN A-2 PHONE: (213) 202–2657 A-3 **PROJECT DESCRIPTION:** ARCHITECTURAL ELEVATIONS A-4 PROJECT SV13736A DRAWLAND FACILITY ENTAILS THE FOLLOWING: ARCHITECTURAL ELEVATIONS A-5 - REMOVE (1) EXISTING 75' LIGHT MUSCO STANDARD - REMOVE EXISTING CHAIN LINK FENCE - REMOVE EXISTING CONCRETE PAD - RELOCATE EXISTING LIGHT FIXTURES AND LIGHT CONTROL CABINES - INSTALL (1) NEW 85' HIGH MUSCO LIGHT STANDARD - INSTALL (2) NEW RBS 6102 OUTDOOR EQUIPMENT CABINET - INSTALL (1) NEW BBU CABINET - INSTALL (1) NEW GPS ANTENNA - INSTALL (1) NEW 2'Ø MICROWAVE DISH - INSTALL (1) NEW WORK LIGHTS - INSTALL (1) NEW METER PEDESTAL - INSTALL (3) NEW 5' PANEL ANTENNAS - INSTALL (3) NEW 8' PANEL ANTENNAS - INSTALL (3) NEW 4' PANEL ANTENNAS - INSTALL (3) NEW RADIO - INSTALL NEW CABLE TRAY ROUTE TO INCLUDE INSTALL (6) NEW 6x12 HYBRID CABLES - INSTALL NEW 8' HIGH CMU WALL - INSTALL NEW 4' WIDE METAL GATE ZONING: CITY OF LOS ANGELES LATITUDE: 34°05'20.9"N. 34.089139 LONGITUDE: 118°13'34.4"W. -118.225944 CONSULTING TEAM: THE FOLLOWING PARTIES HEREBY APPROVE AND ACCEPT THESE DOCUMENTS AND AUTHORIZE THE CONTRACTOR TO PROCEED WITH THE CONSTRUCTION DESCRIBED ARCHITECTURAL ENGINEERING: **PROJECT MANAGER:** HEREIN. ALL CONSTRUCTION DOCUMENTS ARE SUBJECT TO REVIEW BY THE LOCAL NATIONAL ENGINEERING & BUILDING DEPARTMENT AND ANY CHANGES AND MODIFICATIONS THEY MAY IMPOSE. SMARTLINK CONSULTING, INC. 18301 VON KARMAN AVE., STE 910 27 ORCHARD IRVINE, CA 92612 PRINT NAME LAKE FOREST, CA. 92630 CONTACT: TIFFANY ROBERTSON PHONE: (949) 716-9990 PHONE: (949) 683-2214 LANDLORD EMAIL: FAX: (949) 716-9997 tiffany.robertson@smartlinkllc.com ZONING REP SITE ACQUISITION: ZONING: DEVELOP. MGR SMARTLINK SMARTLINK 18401 VON KARMAN AVE., STE 400 18401 VON KARMAN AVE., STE 400 CONST. MGR IRVINE, CA 92612 IRVINE, CA 92612 CONTACT: CHRISTIAN TOBIAS CONTACT: SCOTT DUNAWAY MOBILE: (805) 637-0339 MOBILE: N/A PROJECT MGF FMAII EMAIL: christian.tobias@smartlinkllc.com scott@d4communications.com ZONING MGR **RF ENGINEER:** CONSTRUCTION MANAGER: RF ENGINEER T-MOBILE USA T-MOBILE USA 4100 GUARDIAN ST. SUTE #101 4100 GUARDIAN ST. SUTE #101 OPERATIONS SIMI VALLEY, CA 93063 SIMI VALLEY, CA 93063

T-Mobile ® Stick Together®

CITY: **COUNTY: JURISDICTION:**

LOS LOS **CITY OF L** PARK & R

ANTENNA LAYOUT AND EQUIPMENT LAYOUT

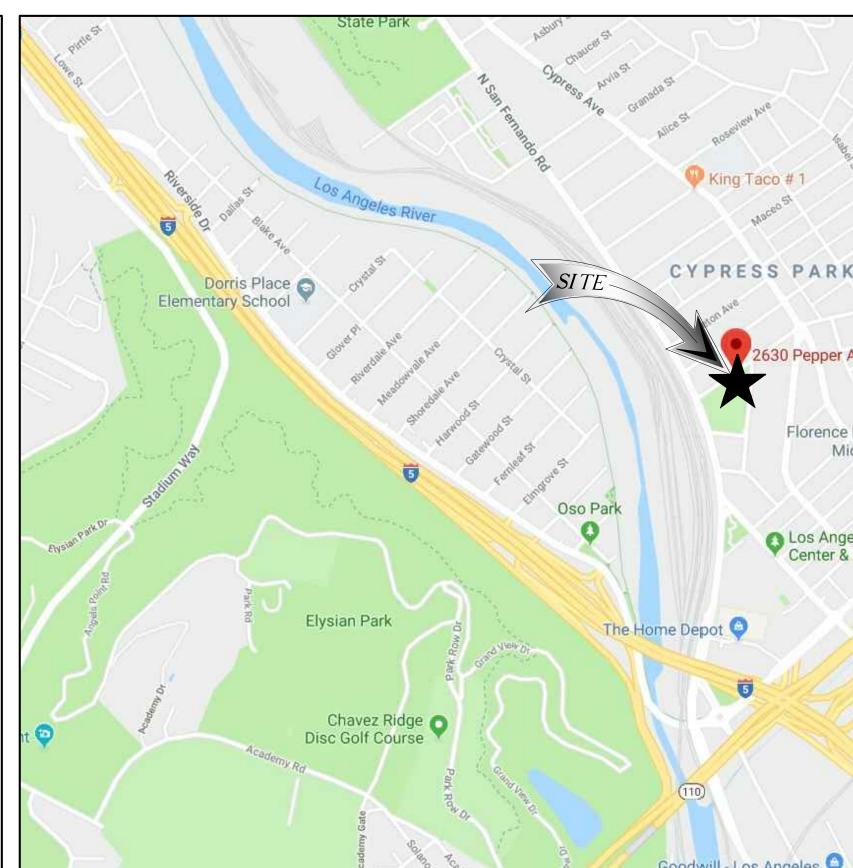

APPROVALS:

SIGNATURE DATE

- DIRECTIONS FROM SIMI VALLEY T-MOBILE OFFICE:
- HEAD SOUTHWEST ON GUARDIAN ST TOWARD TAPO CANYON RD. TURN RIGHT ONTO TAPO CANYON RD. TURN RIGHT TO MERGE ONTO CA-118 E. 4. FOLLOW CA-118 E, I-210 E AND CA-2 S/GLENDALE FWY TO N SAN FERNANDO RD 5. MERGE ONTO CA-118 E. 6. USE THE LEFT 3 LANES TO TURN SLIGHTLY LEFT TO STAY ON CA-118 E. 7. USE THE LEFT 3 LANES TO TAKE EXIT 46A TO MERGE ONTO I-210 E. 8. USE THE RIGHT 3 LANES TO TAKE EXIT 19 TO MERGE ONTO CA-2 S/GLENDALE FWY 9. TAKE EXIT 14 FOR SAN FERNANDO RD. 10. FOLLOW N SAN FERNANDO RD TO PEPPER AVE. 11. USE THE LEFT 2 LANES TO TURN LEFT ONTO N SAN FERNANDO RD. 12. TURN LEFT ONTO PEPPER AVE. DESTINATION WILL BE ON THE RIGHT 2630 PEPPER AVE. LOS ANGELES, CA 90065 **APPLICABLE CODES**

ALL WORK AND MATERIALS SHALL BE PERFORMED AND INSTALLED IN ACCORDANCE WITH THE CURRENT EDITIONS OF THE FOLLOWING CODES AS ADOPTED BY THE LOCAL GOVERNING AUTHORITIES. NOTHING IN THESE PLANS IS TO BE CONSTRUED TO PERMIT WORK NOT CONFORMING TO THE LATEST EDITIONS OF THE FOLLOWING CODES. 2016 CALIFORNIA ADMINISTRATIVE CODE. 9. 2016 CALIFORNIA FIRE CODE. (CFC) 2016 CALIFORNIA BUILDING CODE (CBC). 10. 2016 CALIFORNIA GREEN CODE

- 2016 CALIFORNIA ELECTRICAL CODE (CEC). 2016 CALIFORNIA ENERGY CODE. 4
- 5. 2016 CALIFORNIA MECHANICAL CODE (CMC).
- 2016 CALIFORNIA PLUMBING CODE (CPC).
- ANSI/TIA-222-G LIFE SAFETY CODE NFPA-101
- 8. LOCAL BUILDING CODE.

POWER POWER

CONTAC PHONE:

	Exhibit B			
	F - Mobile Stick Together ⁴¹⁰⁰ GUARDIAN ST, SUITE 101 SIMI VALLEY, CA 93063			
ANGELES ANGELES RECREATION	PLANS PREPARED BY: NATIONAL ENGINEERING & CONSULTING, INC 27 ORCHARD, LAKE FOREST, CA 92630 PHONE: (949) 716-9990 FAX: (949) 716-9997 CONSULTANT: NOTE: Simplify and the second			
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	SHEET TITLE:			
	SHEET NUMBER:			

LEGE	ND
	FIRE HYDRANT
ICV —	IRRIGATION CONTROL VALVE
ICB —	IRRIGATION CONTROL BOX
WM —	WATER METER
	WATER VALVE
	WATER SPIGOT
	DRINKING FOUNTAIN
VT –	
DRN –	
VLT —	
CPB —	COMMUNICATION PULLBOX
UPB —	UNKNOWN PULLBOX
EPB —	ELECTRICAL PULLBOX
PR —	PULLBOX
• —	STREET LIGHT
	LIGHT STANDARD
	TRAFFIC SIGNAL
	CROSSWALK BUTTON
	UNKNOWN MANHOLE
	ELECTRICAL MANHOLE
SWCO —	SEWER CLEANOUT
SWMH —	SEWER MANHOLE
SDCO -	STORM DRAIN CLEANOUT
	STORM DRAIN MANHOLE
	CATCH BASIN
	EDGE OF PAVEMENT
EOC –	EBGE OF GONORETE
	CHAIN LINK FENCE
	WROUGHT IRON FENCE
	PLANTER AREA
TE —	TRASH ENCLOSURE
FP -	FLAG POLE
ECAB —	ELECTRICAL CABINET
PPL -	PARAPET
PPT -	PARAPET TOP
	PARAPET WALL
	ROOF HATCH
DK –	
	ELECTRICAL BOX
	AIR CONDITIONING UNIT
	INCHES
	FINISHED FLOOR
FS —	FINISHED SURFACE
FL —	FLOW LINE
GL —	GUTTER LIP
	TOP OF CURB
TP –	
	NATURAL GROUND
	ANTENNA
	TREE
	POWER POLE
	HOUSE
	GATE OPENER BOX
	ELECTRIC METER
STP –	STEPS

FD MAG & WASHER, LA CITY SURVEYOR, FLUSH

SURVEYOR'S NOTES:

BASIS OF BEARINGS: THE BASIS OF BEARINGS FOR THIS SURVEY IS THE CALIFORNIA COORDINATE SYSTEM (NAD83), ZONE 5, AS DETERMINED LOCALLY BY THE LINE BETWEEN NATIONAL GEODETIC SURVEY (NGS) CONTINUOUSLY OPERATING REFERENCE STATION (CORS) VDCY & CRHS. THE BEARING OF SAID LINE BEING NO7°11'46.50"E BETWEEN SAID STATIONS.

BENCHMARK: CITY OF LOS ANGELES BM 12-25037

WIRE SPIKE NORTH CURB POPLAR STREET; 35.6' EASTERLY OF SAN FERNANDO ROAD; WEST END CATCH BASIN

ELEVATION=340.031' (NAVD88)

DATE OF SURVEY: FEBRUARY 20, 2019

NOTE: THE CENTERLINE AND RIGHT OF WAY LINES WITH THEIR DIMENSIONS SHOWN HEREON ARE PER READILY AVAILABLE RECORDED INFORMATION AND THEIR LOCATIONS ARE APPROXIMATE PENDING RECEIPT OF TITLE REPORT(S) FOR THE ADJACENT REAL PROPERTY.


<u>LIVING PLANTS STATEMENT:</u> THE HEIGHTS AND ELEVATIONS FOR THE TREES, BUSHES AND OTHER LIVING PLANTS SHOWN HEREON, SHOULD BE CONSIDERED APPROXIMATE (+/-) AND ONLY VALID FOR THE DATE OF THIS SURVEY. THEY ARE PROVIDED AS A GENERAL REFERENCE AND SHOULD NOT BE USED FOR DESIGN PURPOSES.


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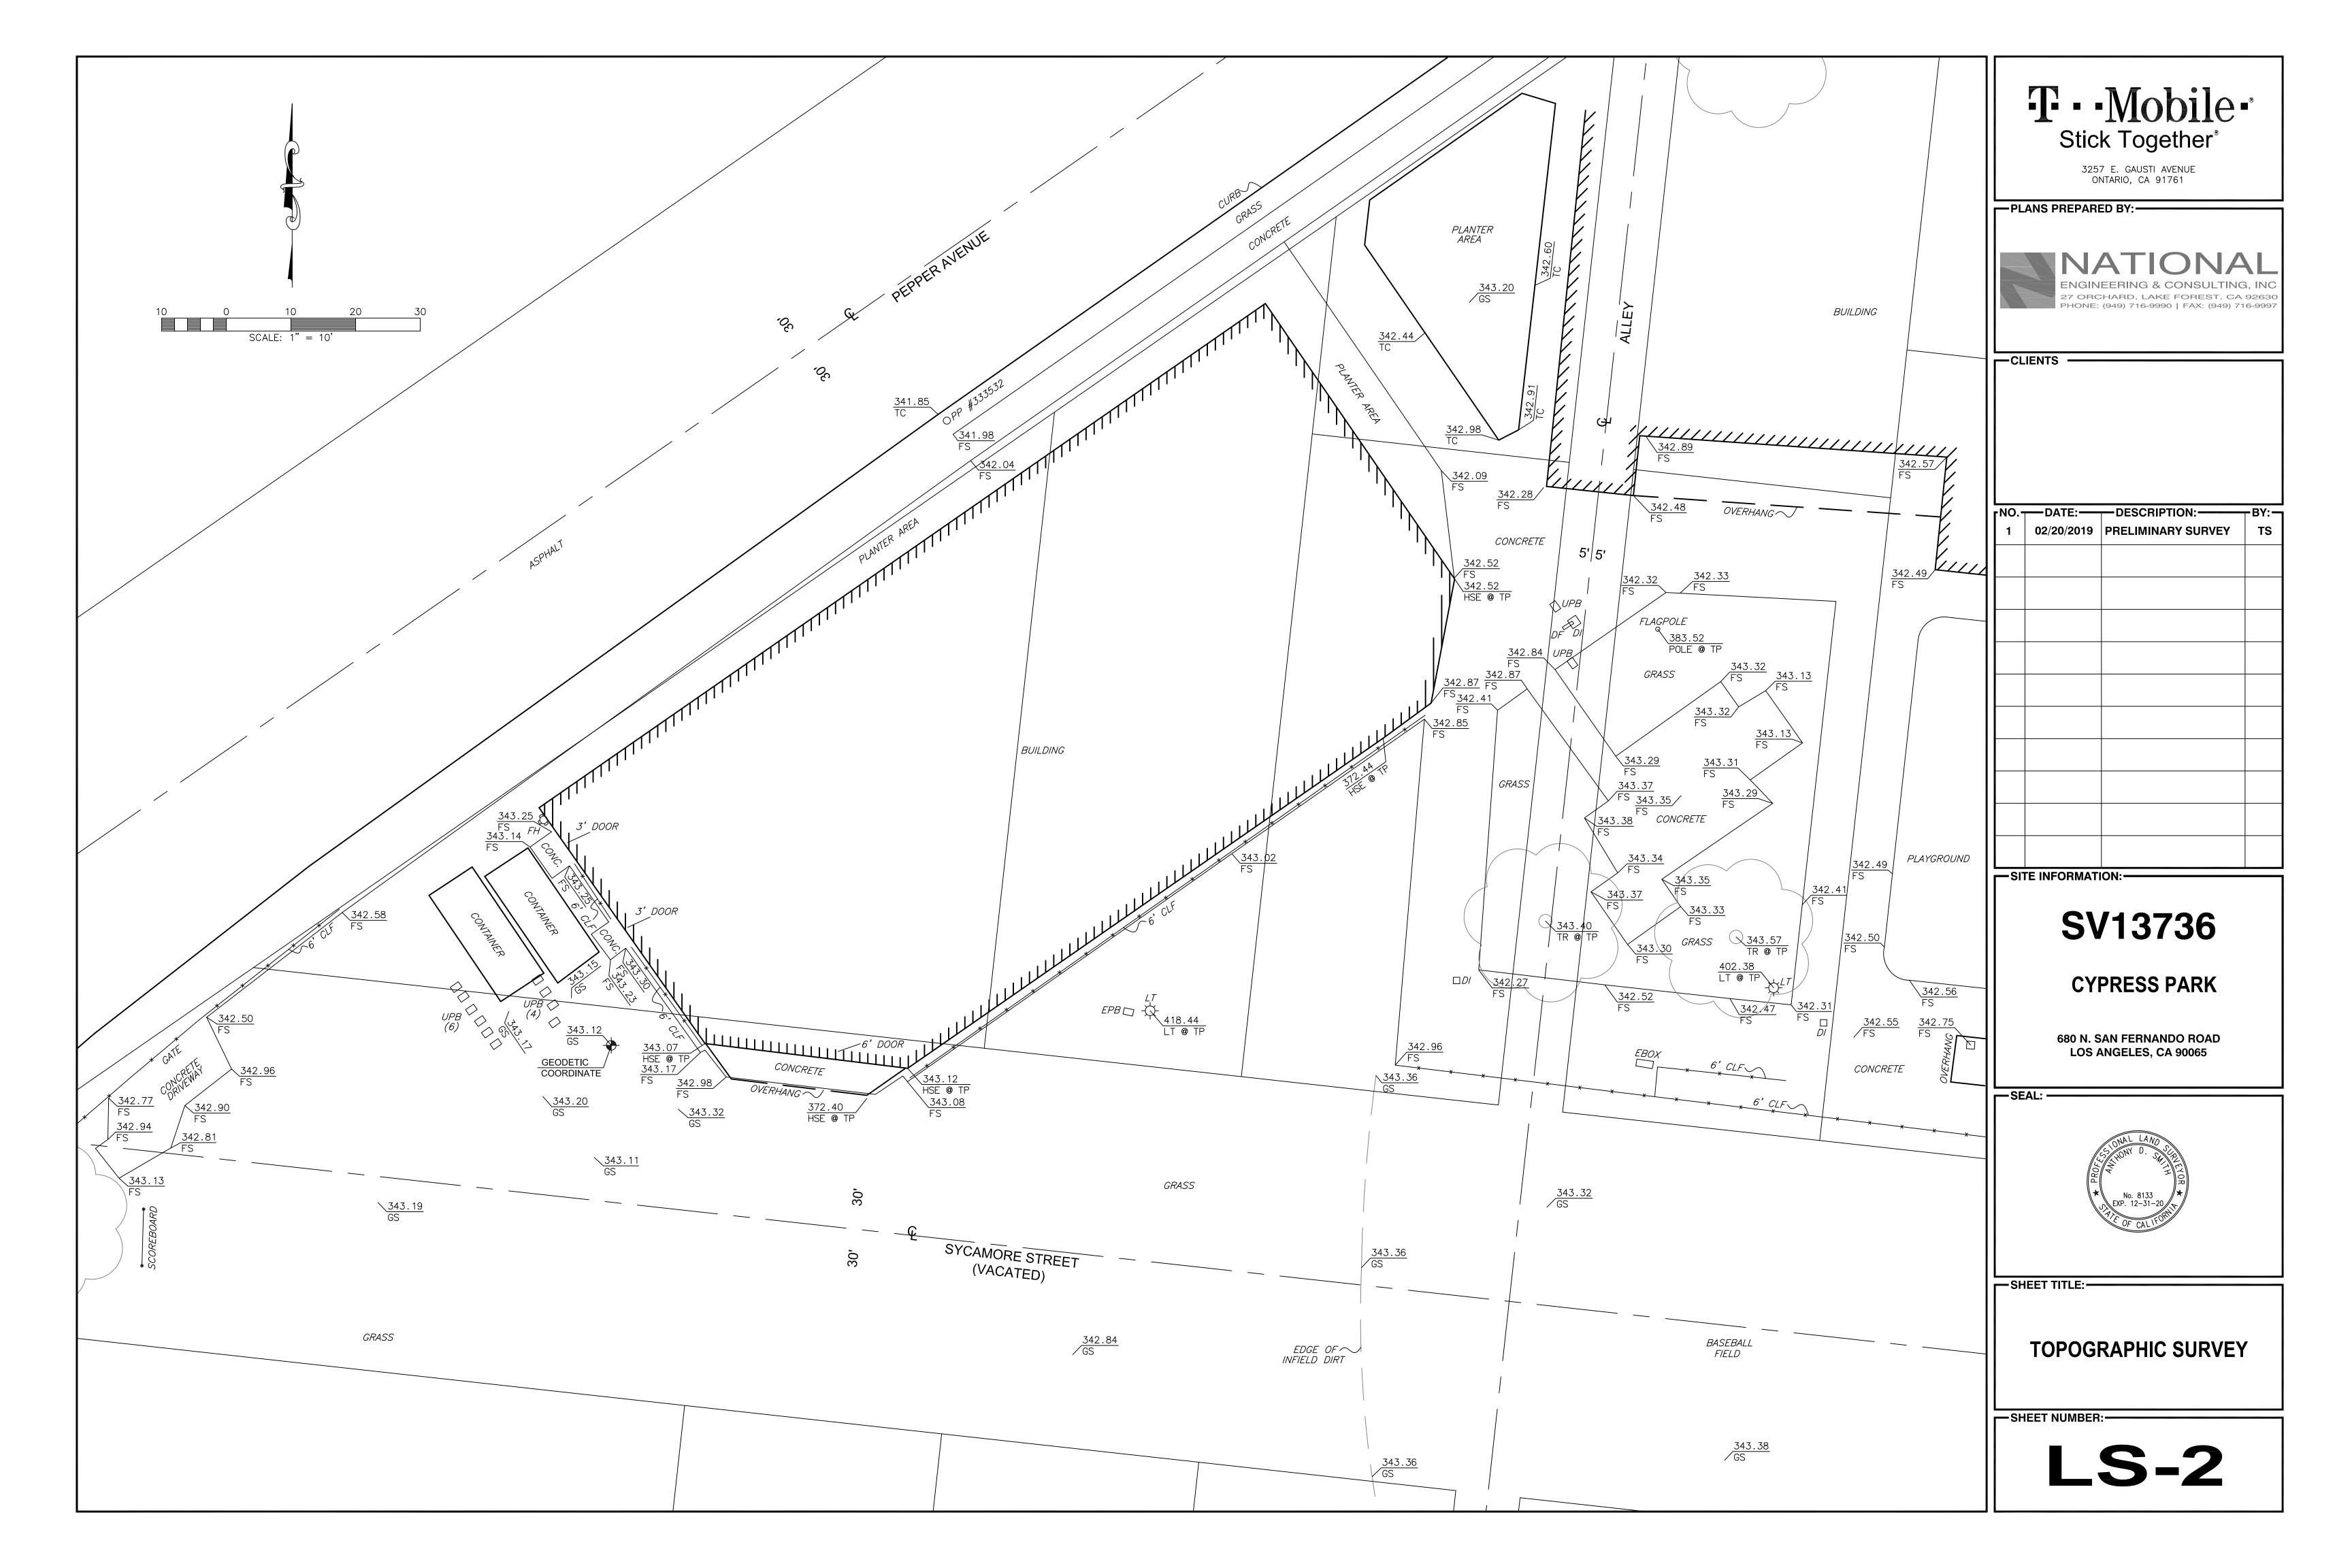
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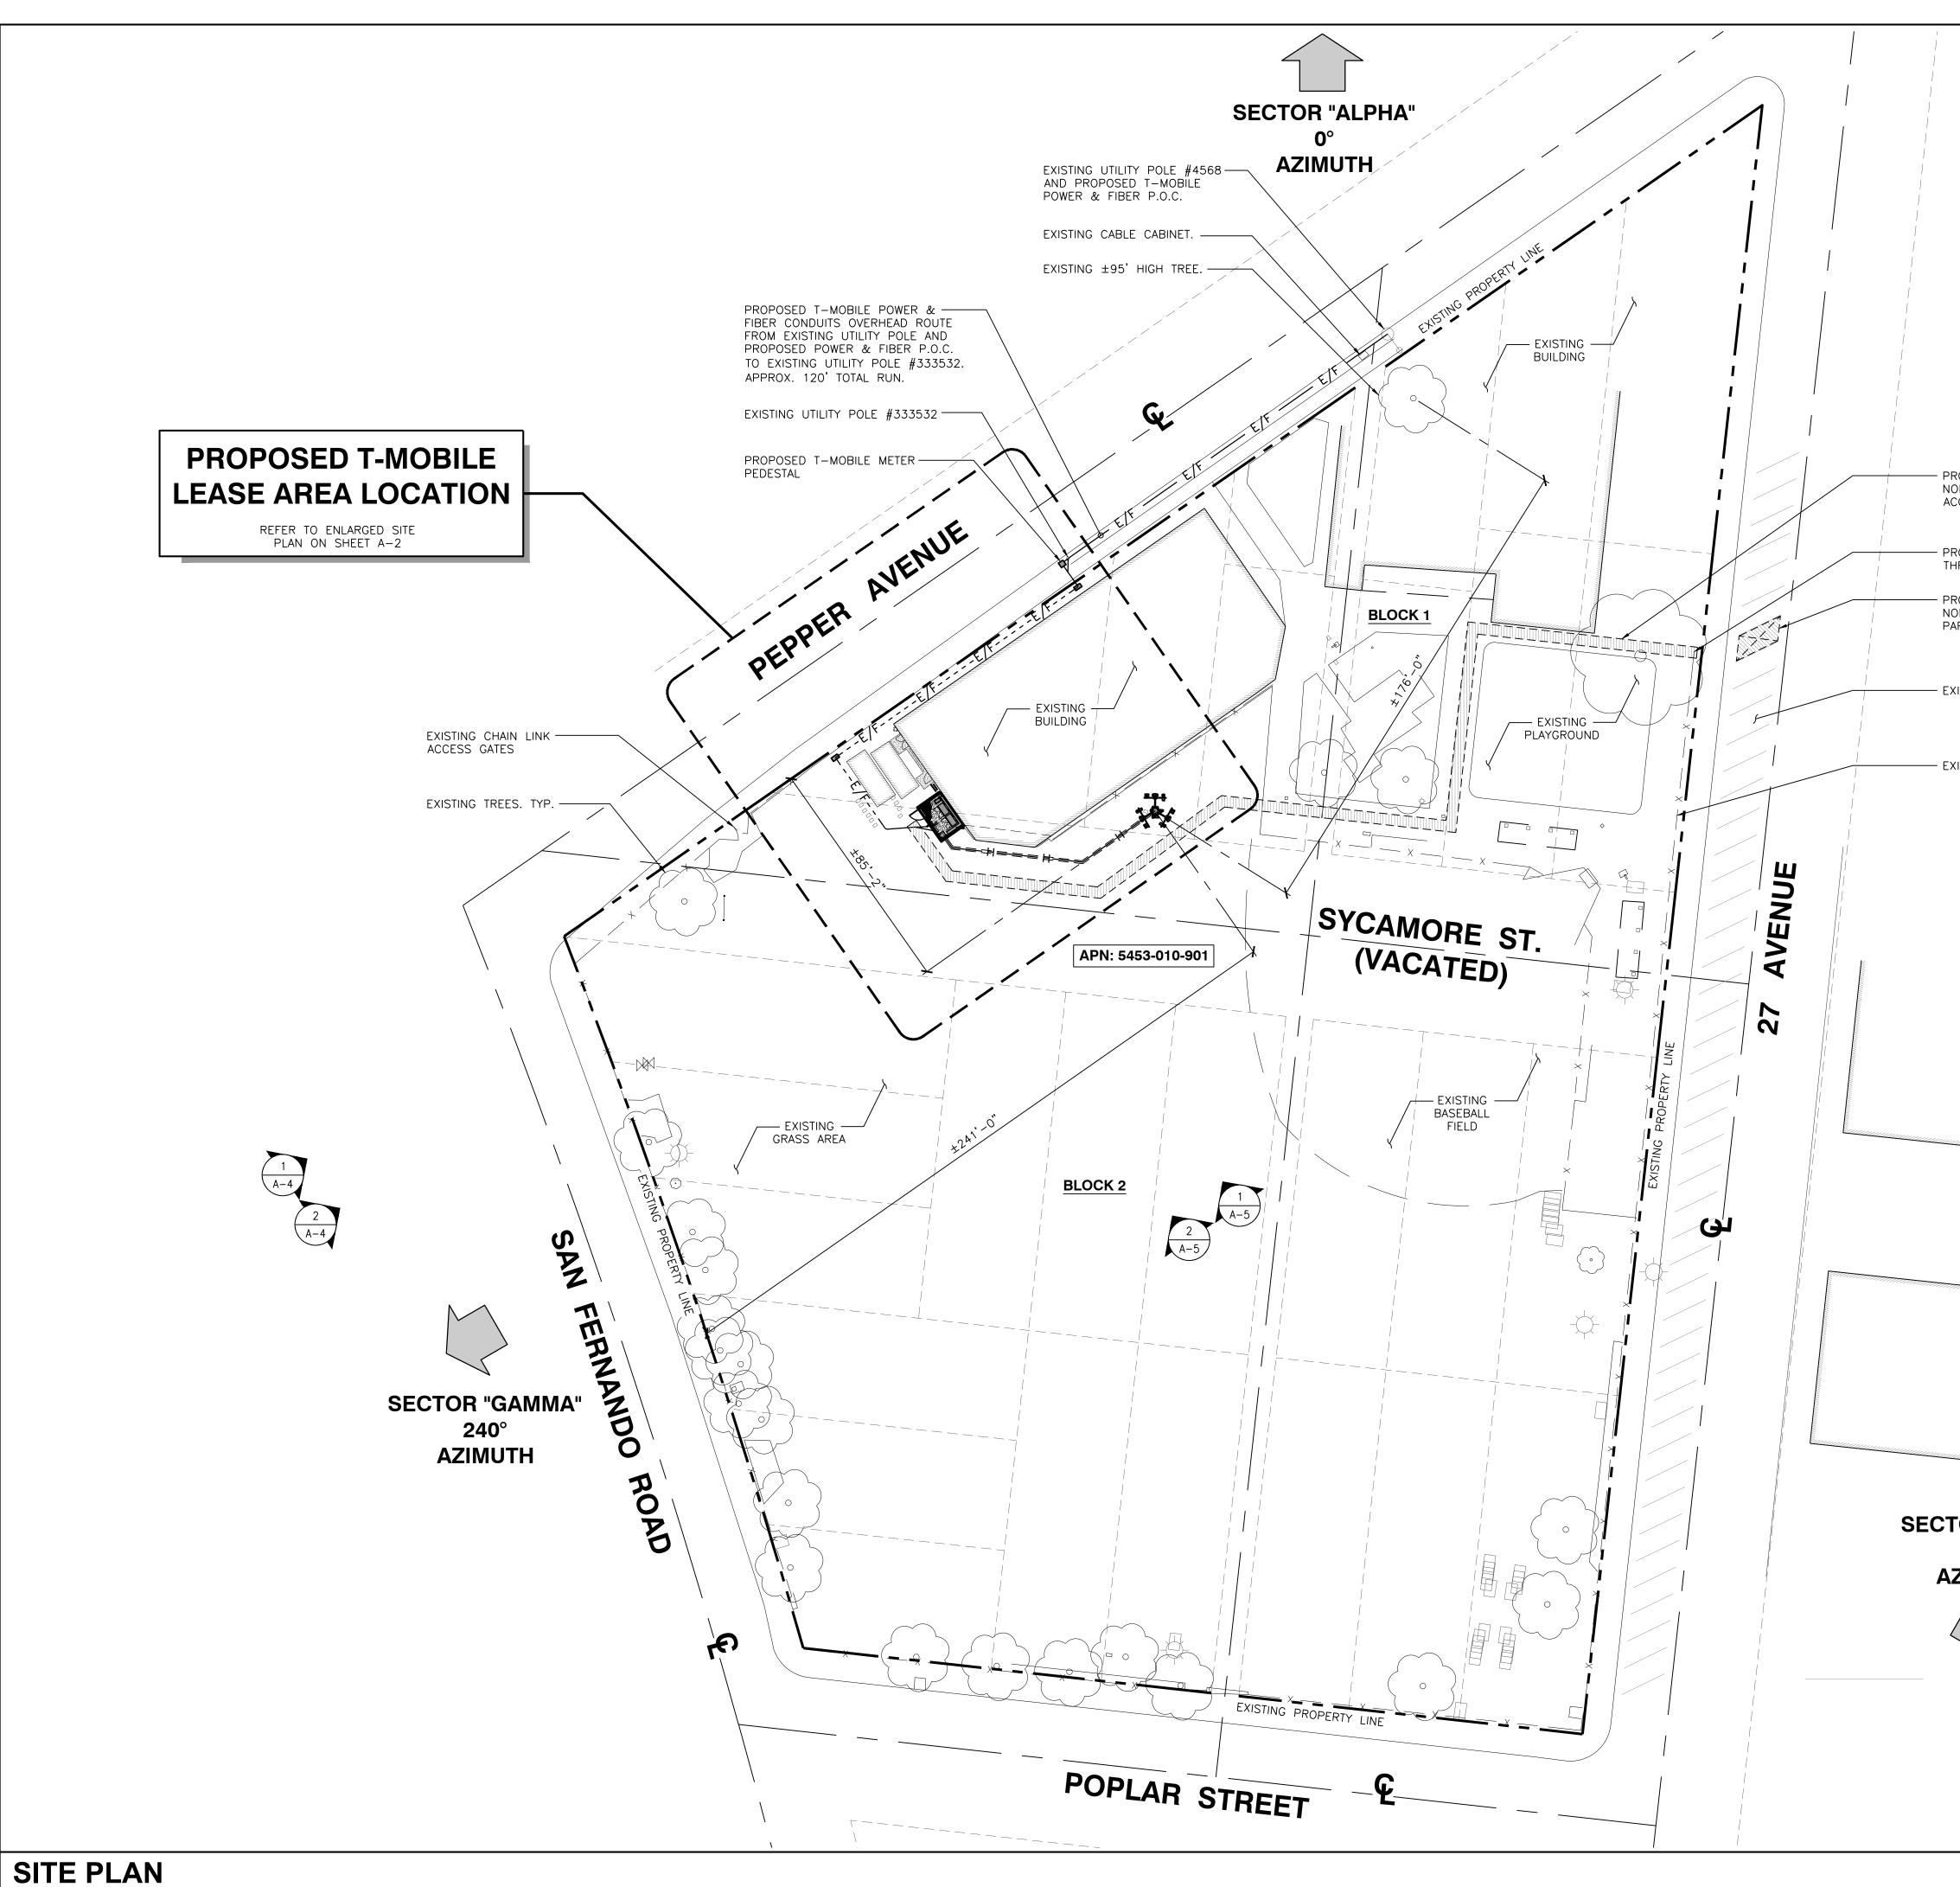
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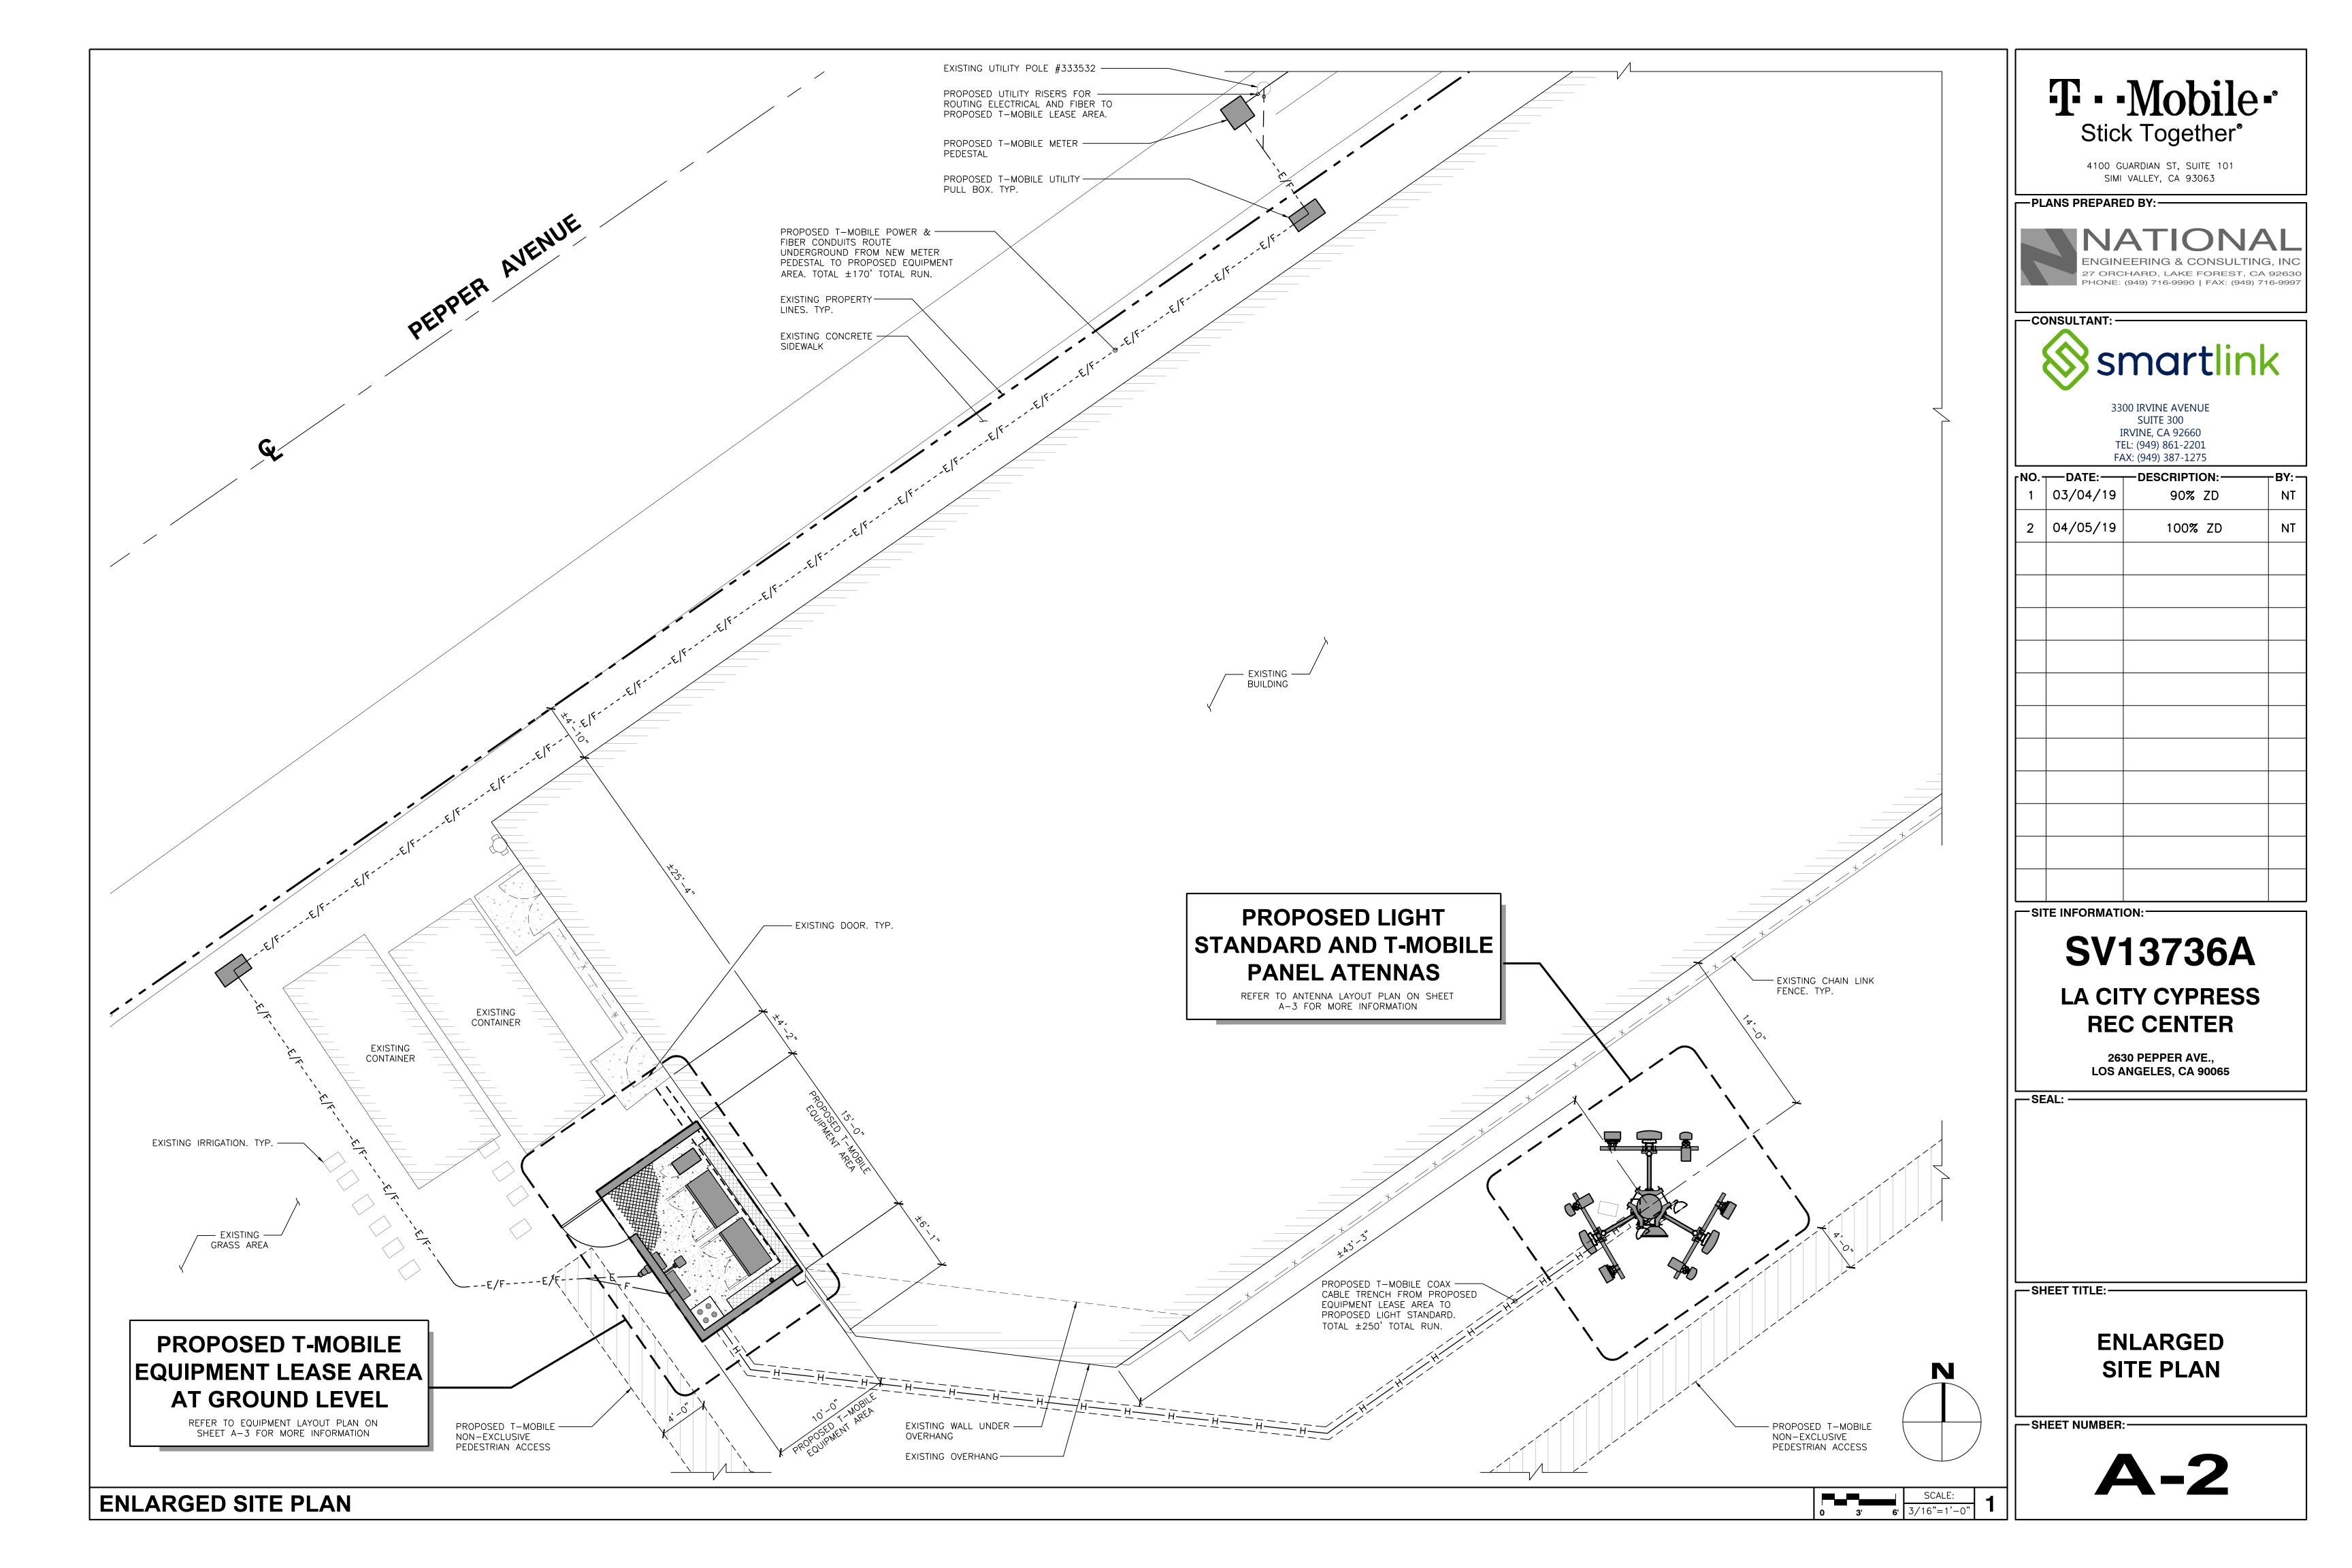



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ROPOSED T–MOBILE ION–EXCLUSIVE PEDESTRIAN ICCESS			IF	00 IRVINE AVENUE SUITE 300 RVINE, CA 92660 L: (949) 861-2201	
PROPOSED T-MOBILE ACCESS THROUGH EXISTING GATE			FA	X: (949) 387-1275	BY:
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T • • Mobile • Stick Together[®]

> 4100 GUARDIAN ST, SUITE 101 SIMI VALLEY, CA 93063


PLANS PREPARED BY:

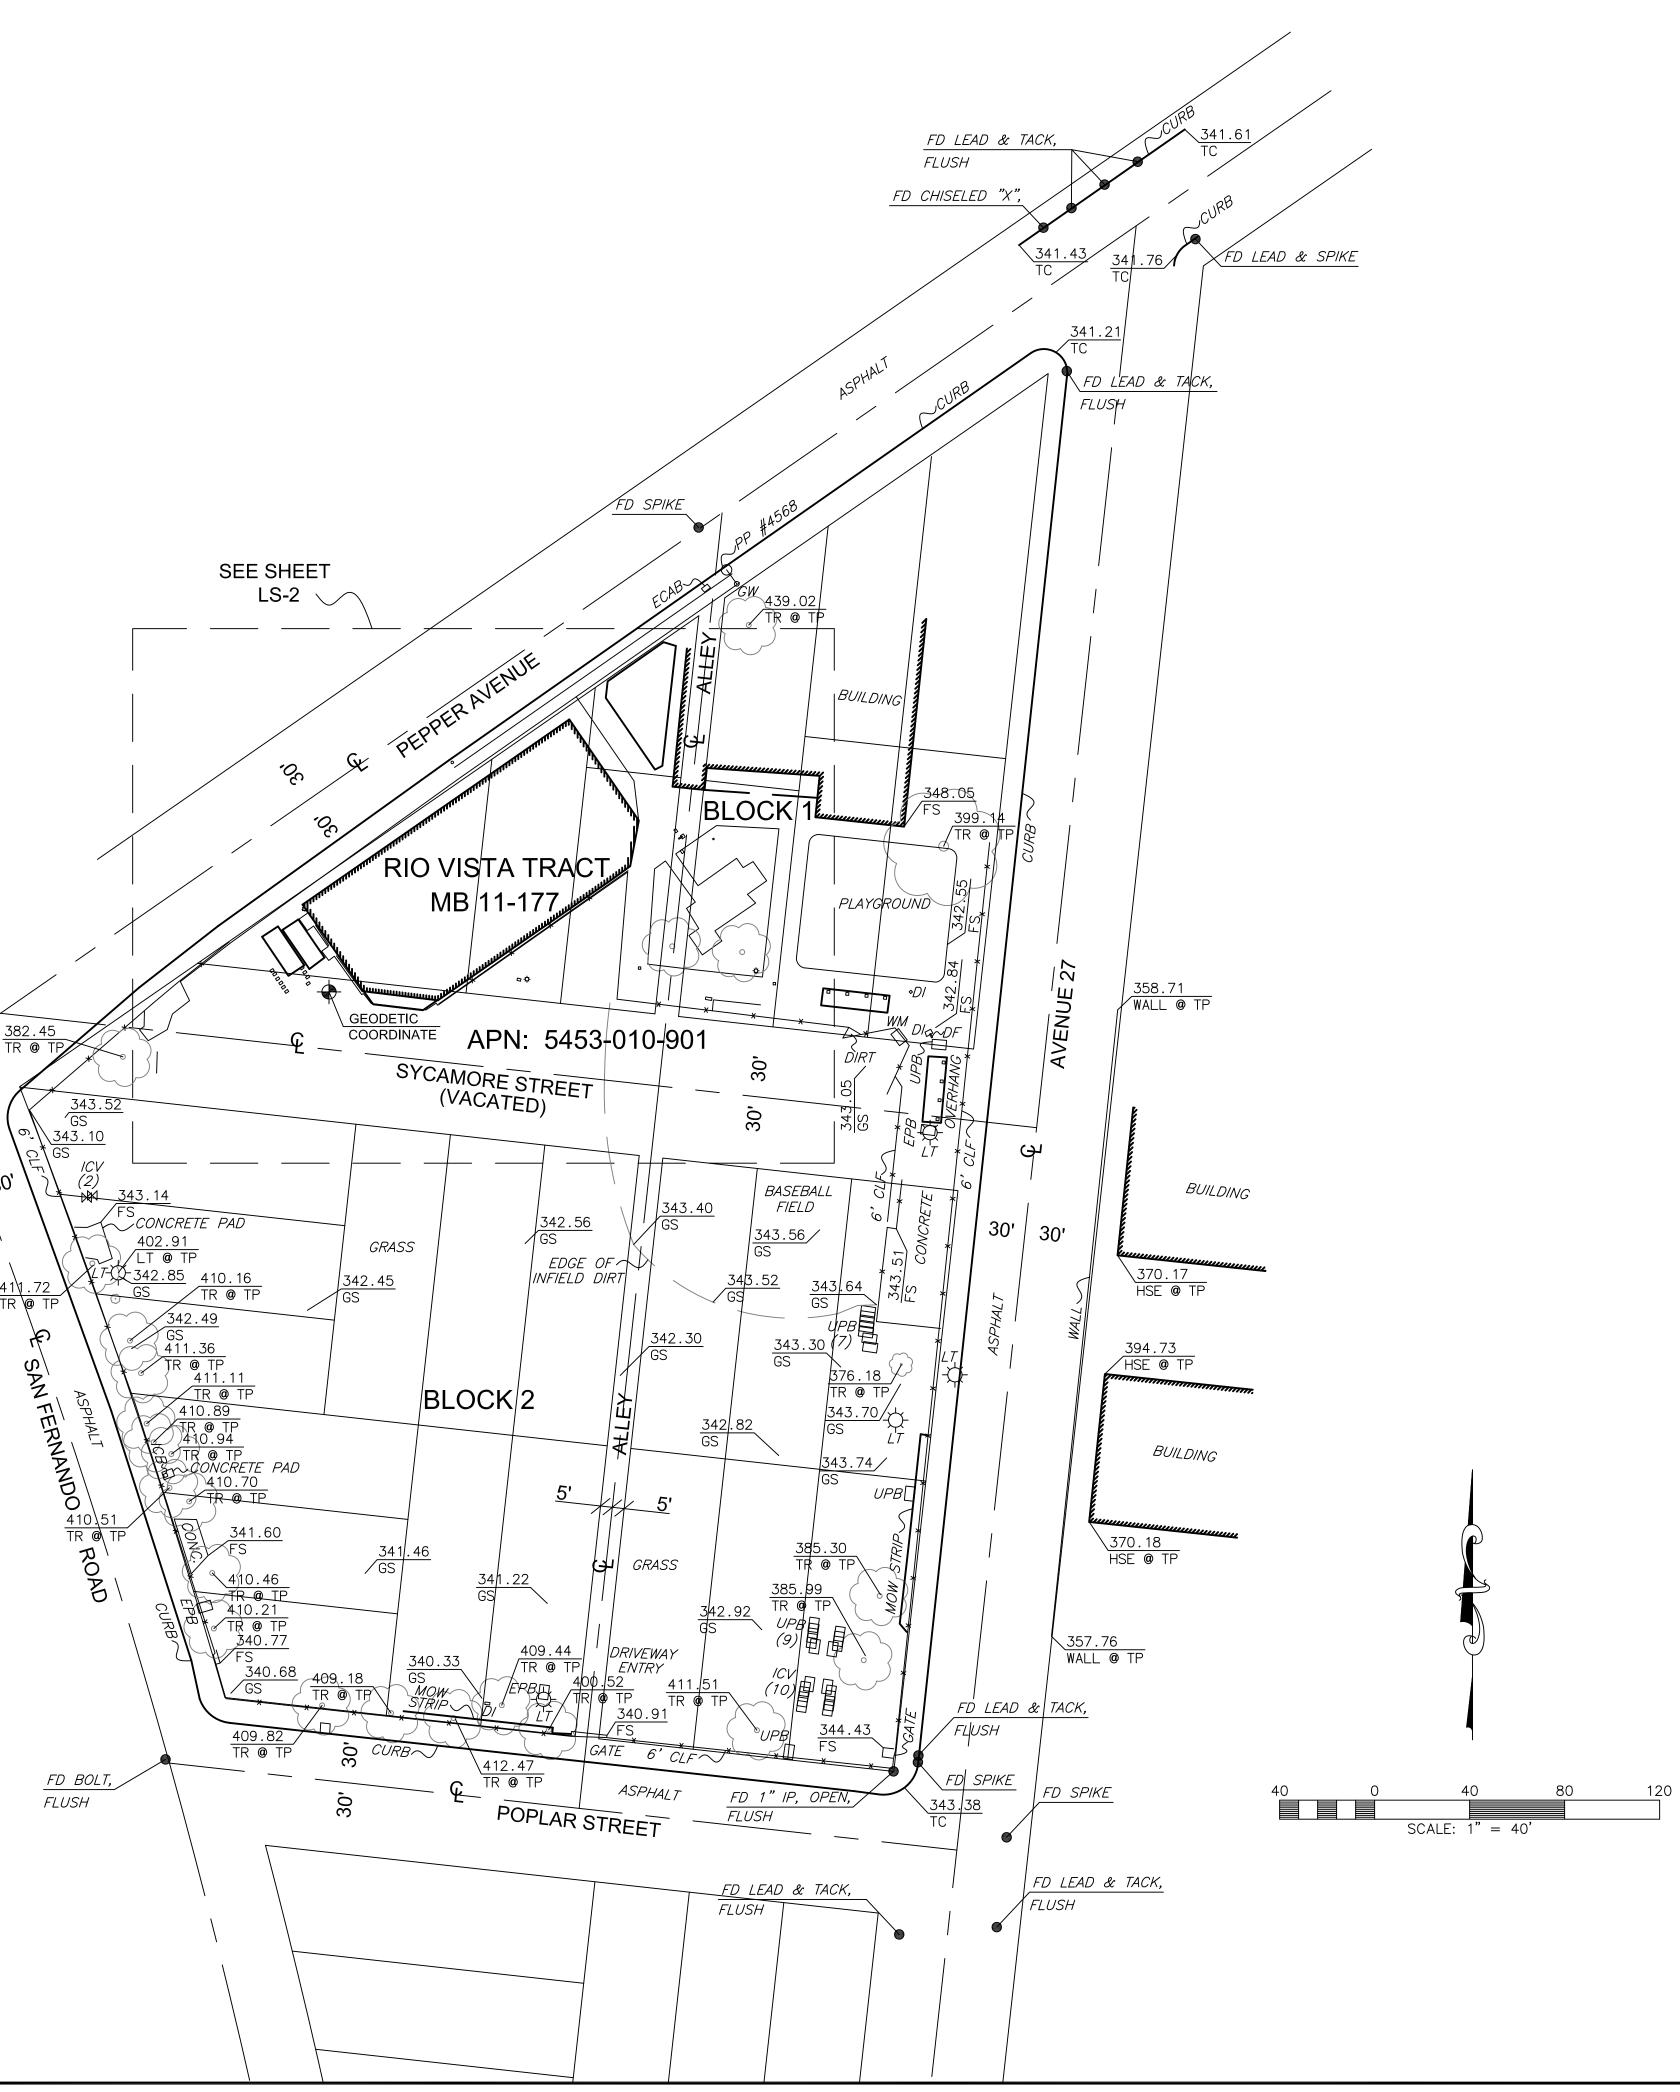

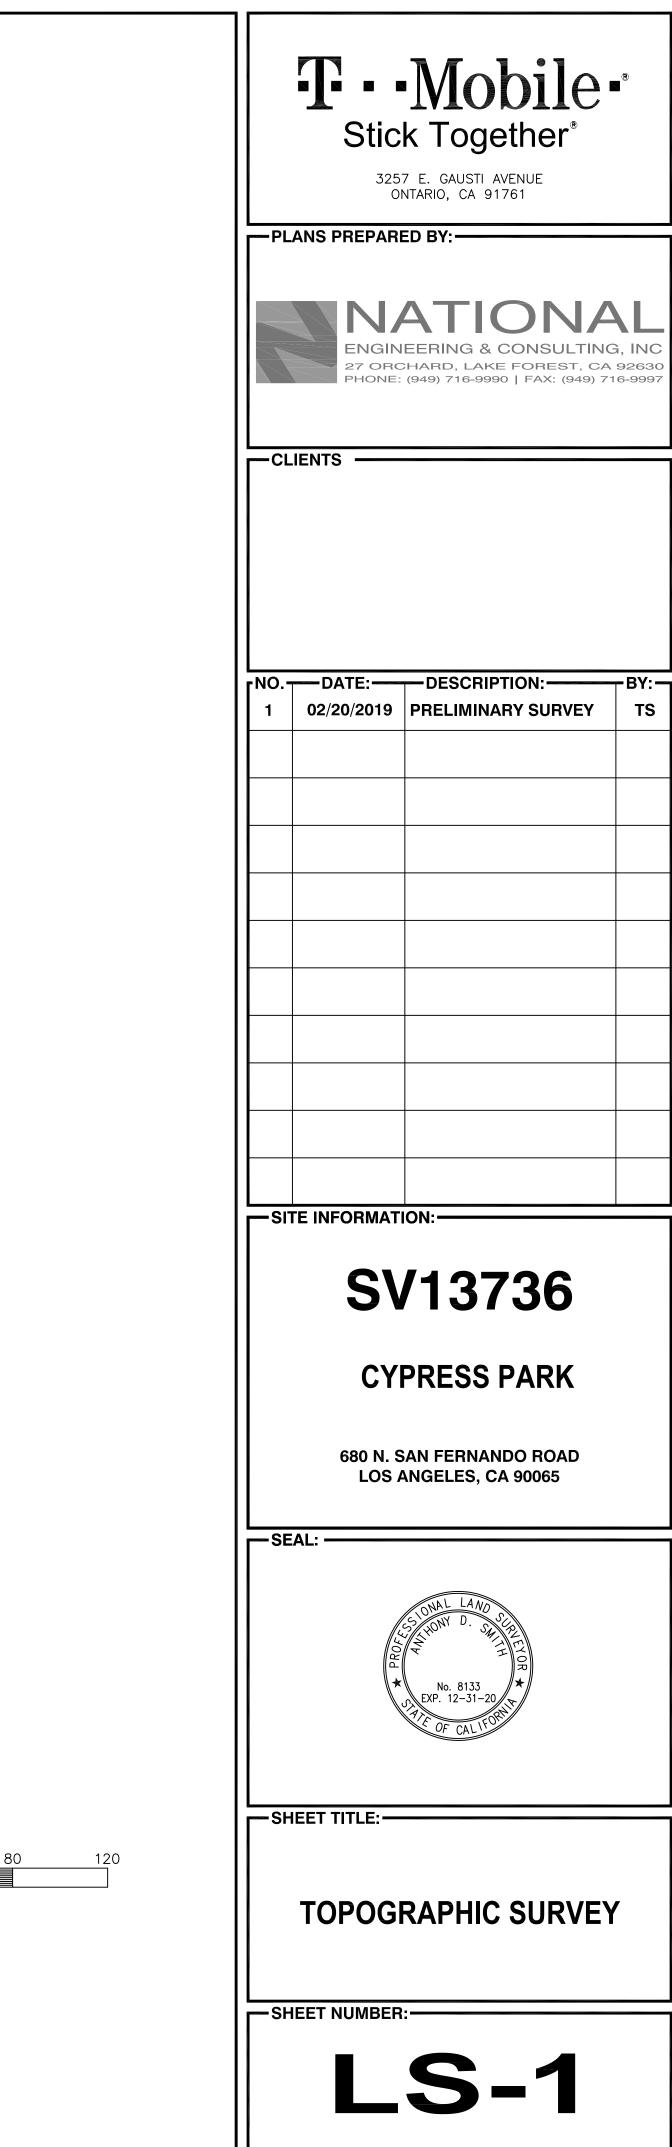

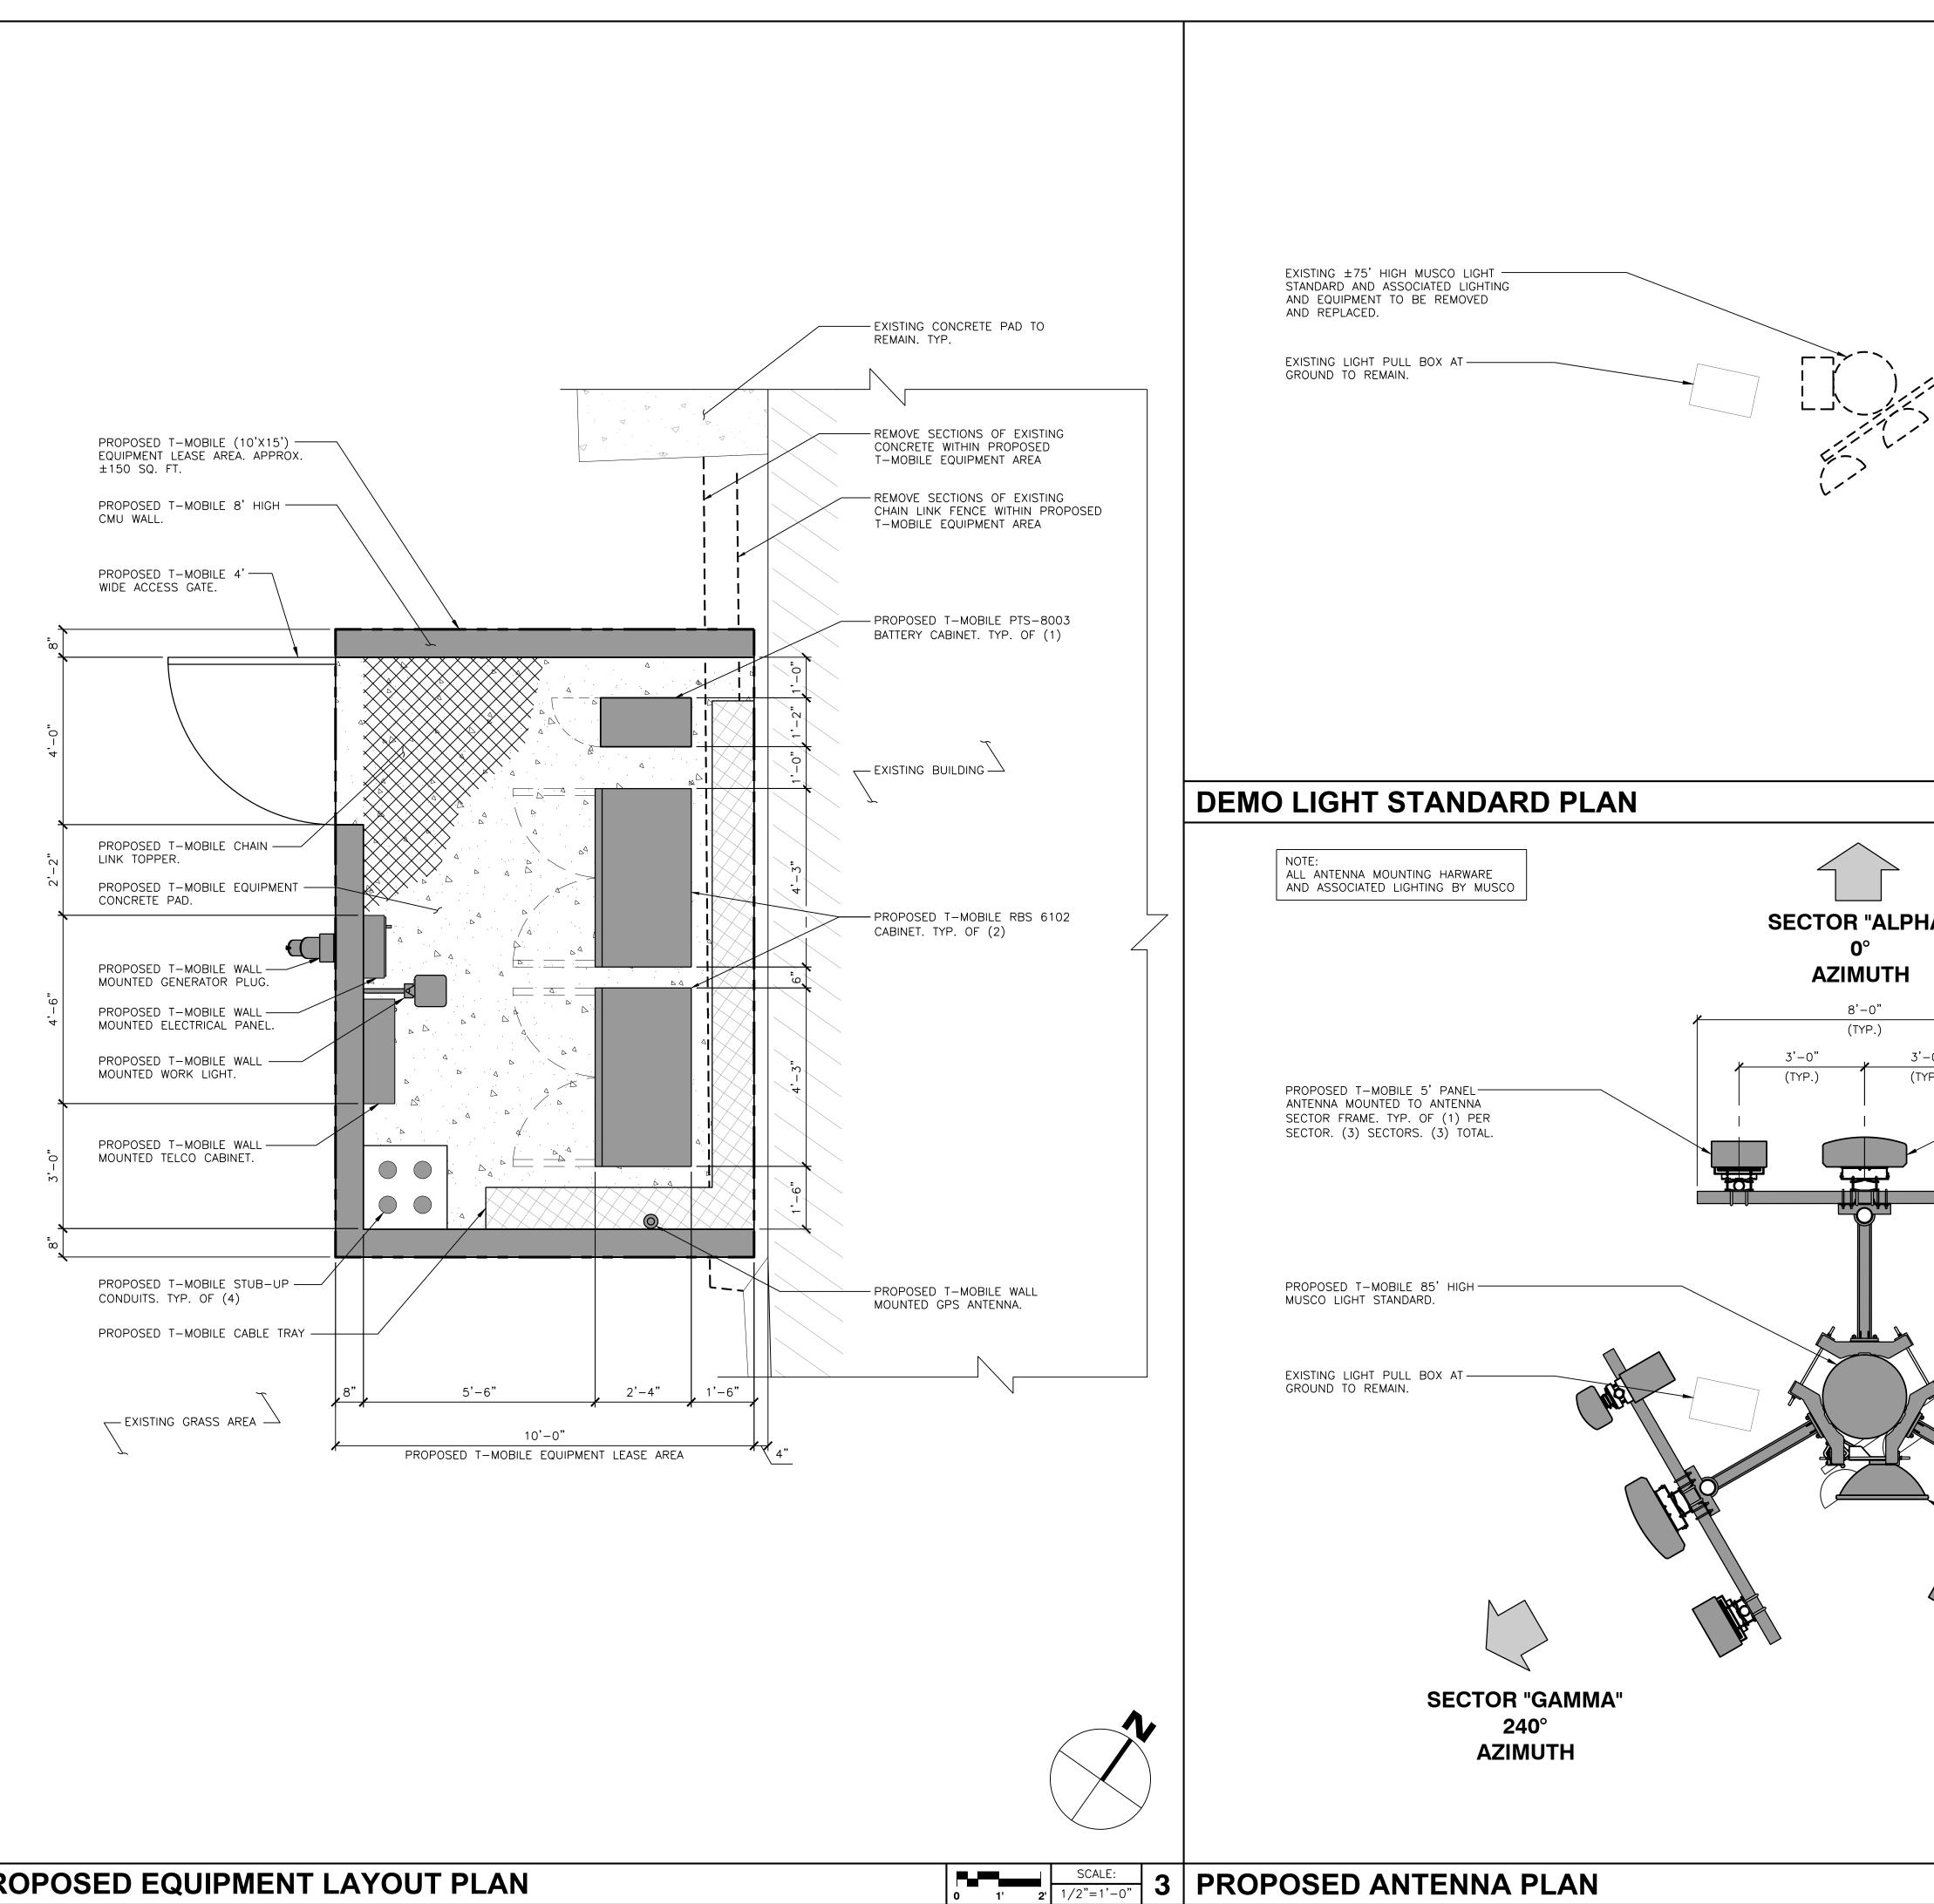PROPOSED EQUIPMENT LAYOUT PLAN

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		PLANS PREPARED BY: NATIONAL ENGINEERING & CONSULTING, INC 27 ORCHARD, LAKE FOREST, CA 92630 PHONE: (949) 716-9990 J FAX: (949) 716-9997 CONSULTANT: CONSULTANT: 3300 IRVINE AVENUE SUITE 300 IRVINE, CA 92660 TEL: (949) 861-2201		
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PROPOSED T-MOBILE 4' PANEL ANTENNA MOUNTED TO ANTENNA SECTOR FRAME. TYP. OF (1) PER SECTOR. (3) SECTORS. (3) TOTAL	 sr	TE INFORMATION	3736A	
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BELOW ANTENNAS. TYP. SECTOR "BETA" 120° AZIMUTH			SELES, CA 90065	
PROPOSED T-MOBILE 2' DIA. MICROWAVE DISH MOUNTED TO PROPOSED LIGHT STANDARD. AZIMUTH TO BE DETERMINED. TYP. OF (1)		ANTANN	A PLAN A ENT LAYO	

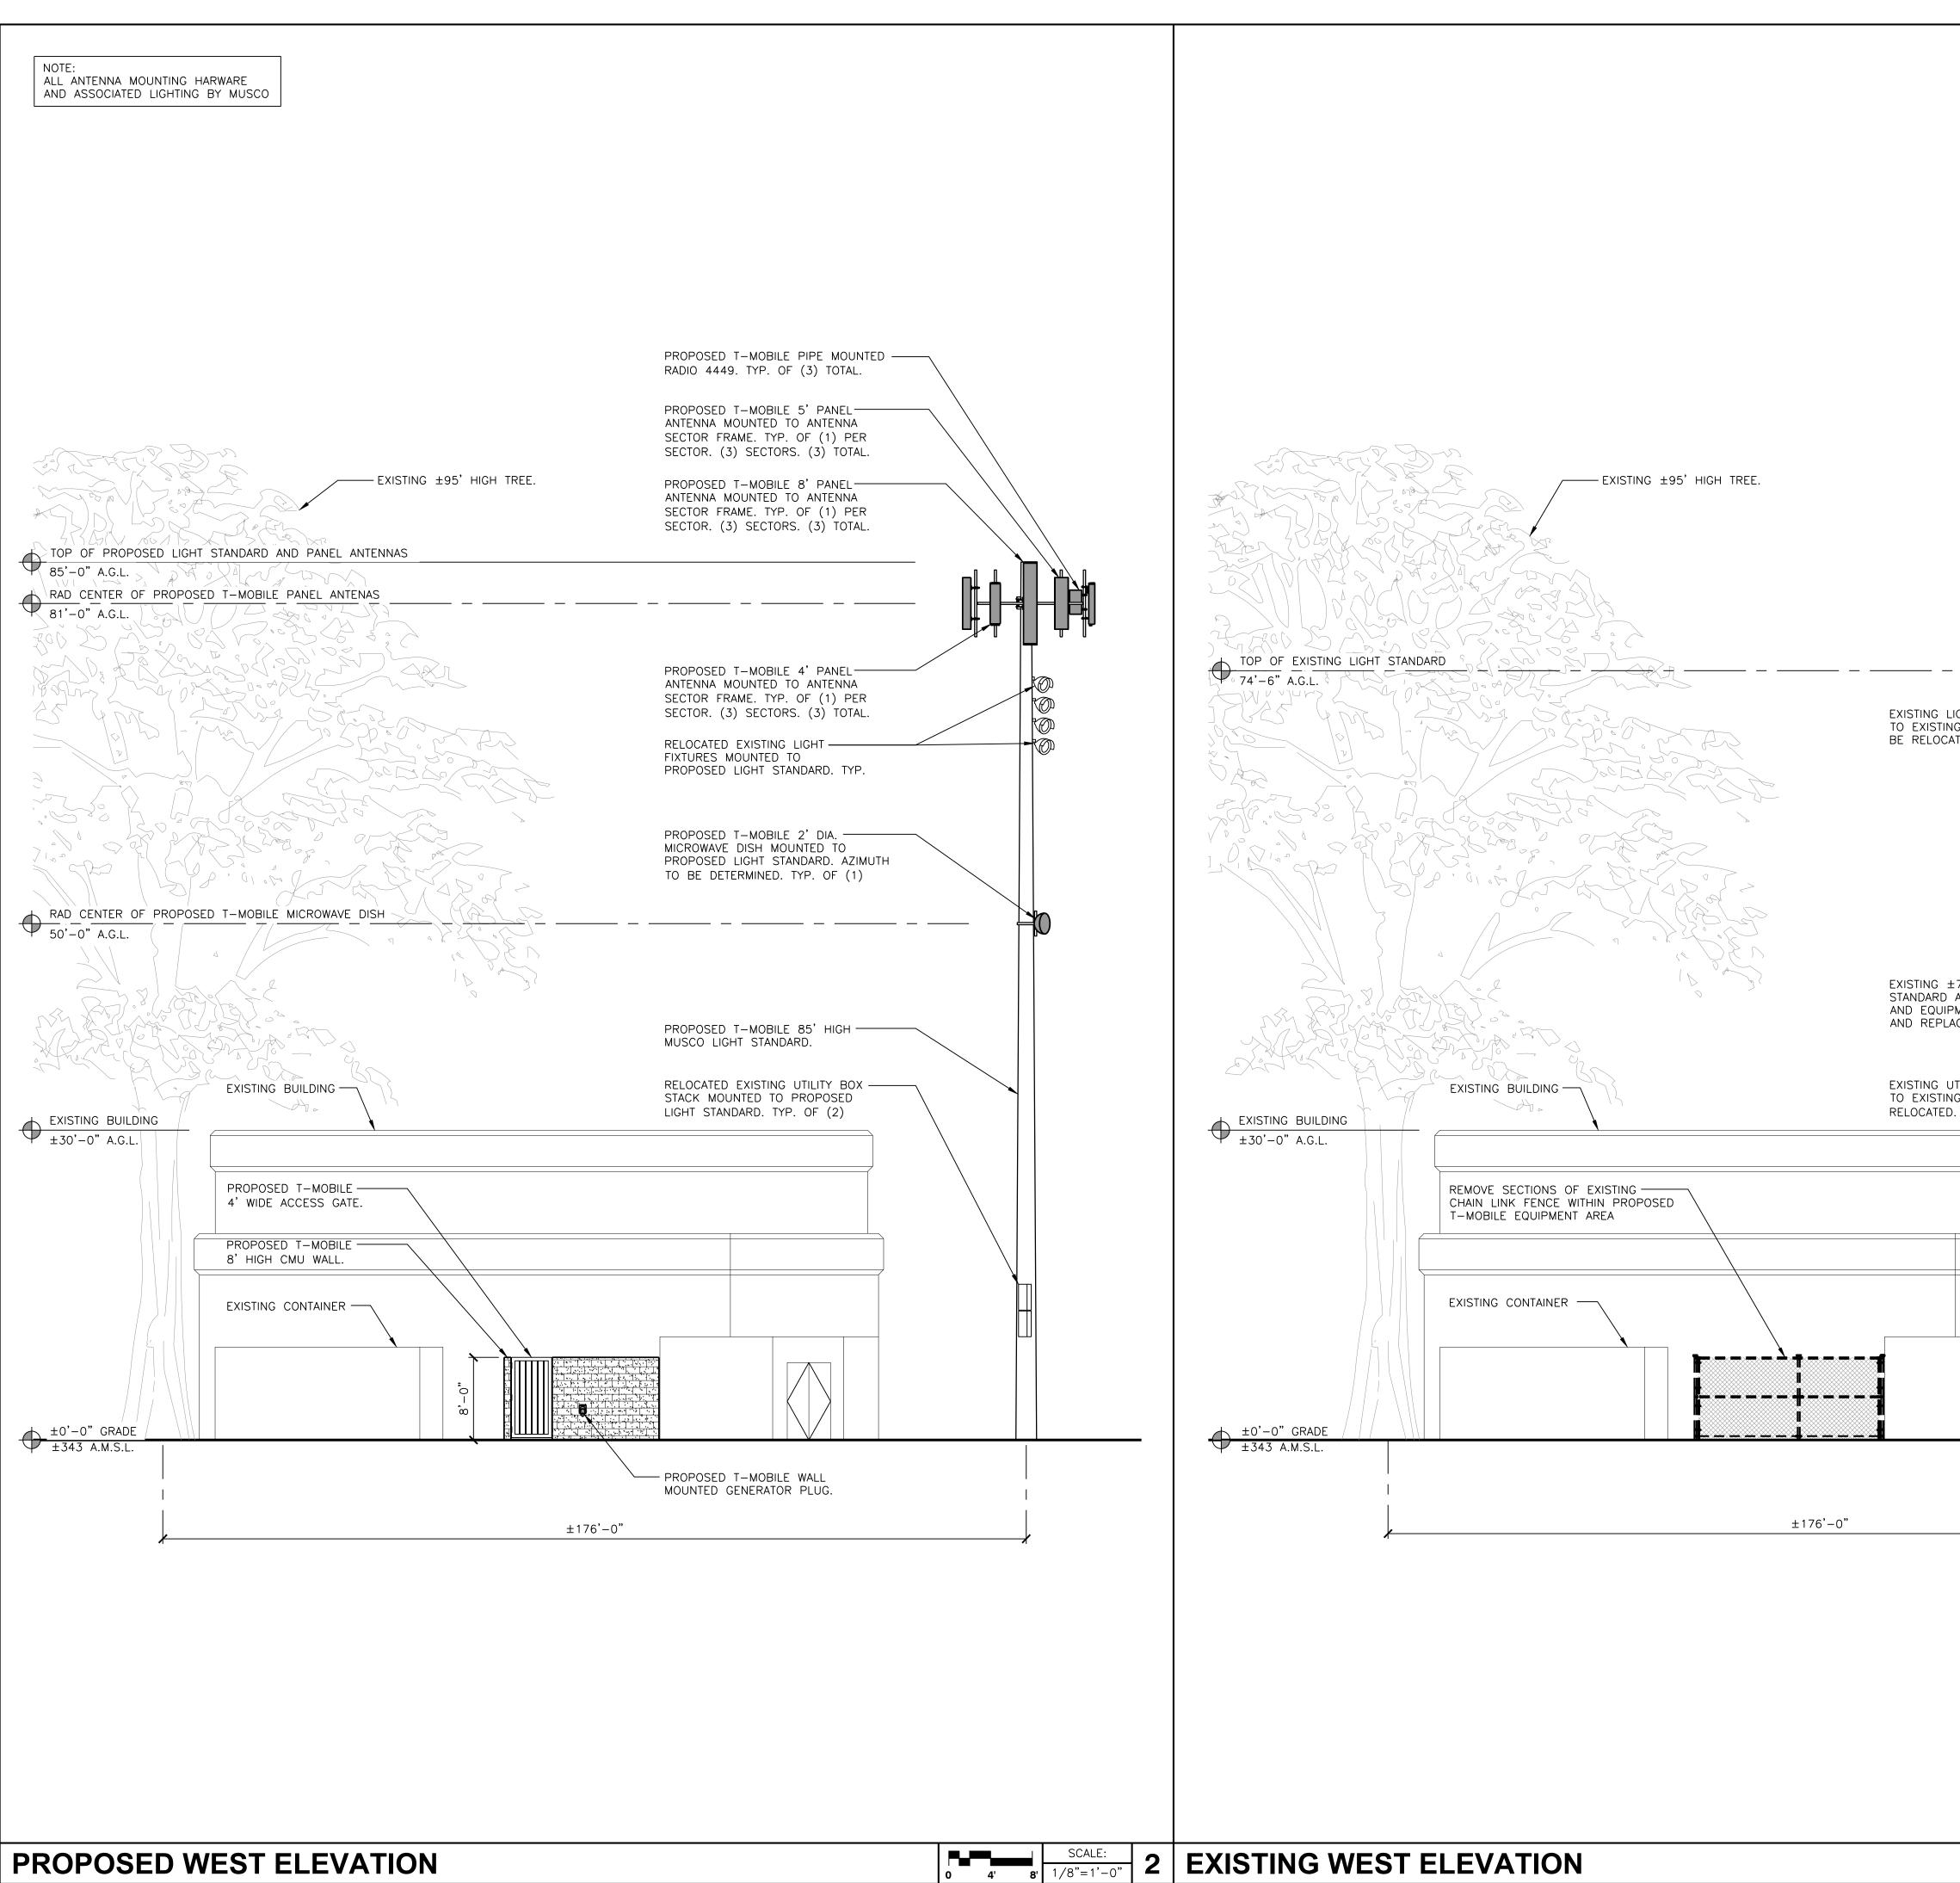


PROPOSED WEST ELEVATION

	F - Mobile - Stick Together ⁴¹⁰⁰ GUARDIAN ST, SUITE 101 SIMI VALLEY, CA 93063
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	NO. DATE: DESCRIPTION: BY: 1 03/04/19 90% ZD NT
LIGHT FIXTURES MOUNTED ING LIGHT STANDARD TO CATED. TYP.	
±75' HIGH MUSCO LIGHT AND ASSOCIATED LIGHTING PMENT TO BE REMOVED ACED. UTILITY BOX STACK MOUNTED NG LIGHT STANDARD TO BE D. TYP. OF (2)	
	SV13736A LA CITY CYPRESS REC CENTER 2630 PEPPER AVE., LOS ANGELES, CA 90065
	SHEET TITLE: ARCHITECTURAL ELEVATIONS
0 4 ' 8 ' 1/8"=1'-	

	PROPOSED T–MOBILE 5' PANEL ANTENNA MOUNTED TO ANTENNA
	SECTOR FRAME. TYP. OF (1) PER SECTOR. (3) SECTORS. (3) TOTAL. PROPOSED T-MOBILE 8' PANEL
	ANTENNA MOUNTED TO ANTENNA SECTOR FRAME. TYP. OF (1) PER SECTOR. (3) SECTORS. (3) TOTAL.
	PROPOSED T–MOBILE 4' PANEL ANTENNA MOUNTED TO ANTENNA SECTOR FRAME. TYP. OF (1) PER SECTOR. (3) SECTORS. (3) TOTAL.
TOP OF PROPOSED LIGHT STANDARD AND PANEL ANTENNAS 85'-0" A.G.L.	
RAD CENTER OF PROPOSED T-MOBILE PANEL ANTENAS	
	PROPOSED T-MOBILE PIPE
	RELOCATED EXISTING LIGHT
	PROPOSED T–MOBILE 2' DIA. MICROWAVE DISH MOUNTED TO PROPOSED LIGHT STANDARD. AZIMUT TO BE DETERMINED. TYP. OF (1)
RAD_CENTER_OF_PROPOSED_T_MOBILE_MICROWAVE_DISH	
30 -0 A.G.L.	
	PROPOSED T-MOBILE 85' HIGH MUSCO LIGHT STANDARD.
	RELOCATED EXISTING UTILITY BOX
TOP OF EXISTING BUILDING ±30'-0" A.M.S.L.	LIGHT STANDARD. TYP. OF (2)
EXISTING BUILDING	
PROPOSED T-MOBILE 8' HIGH CMU WALL.	
EXISTING CONTAINER	EXISTING CHAIN LINK FENCE. TYP
PROPOSED T-MOBILE	

PROPOSED SOUTH ELEVATION

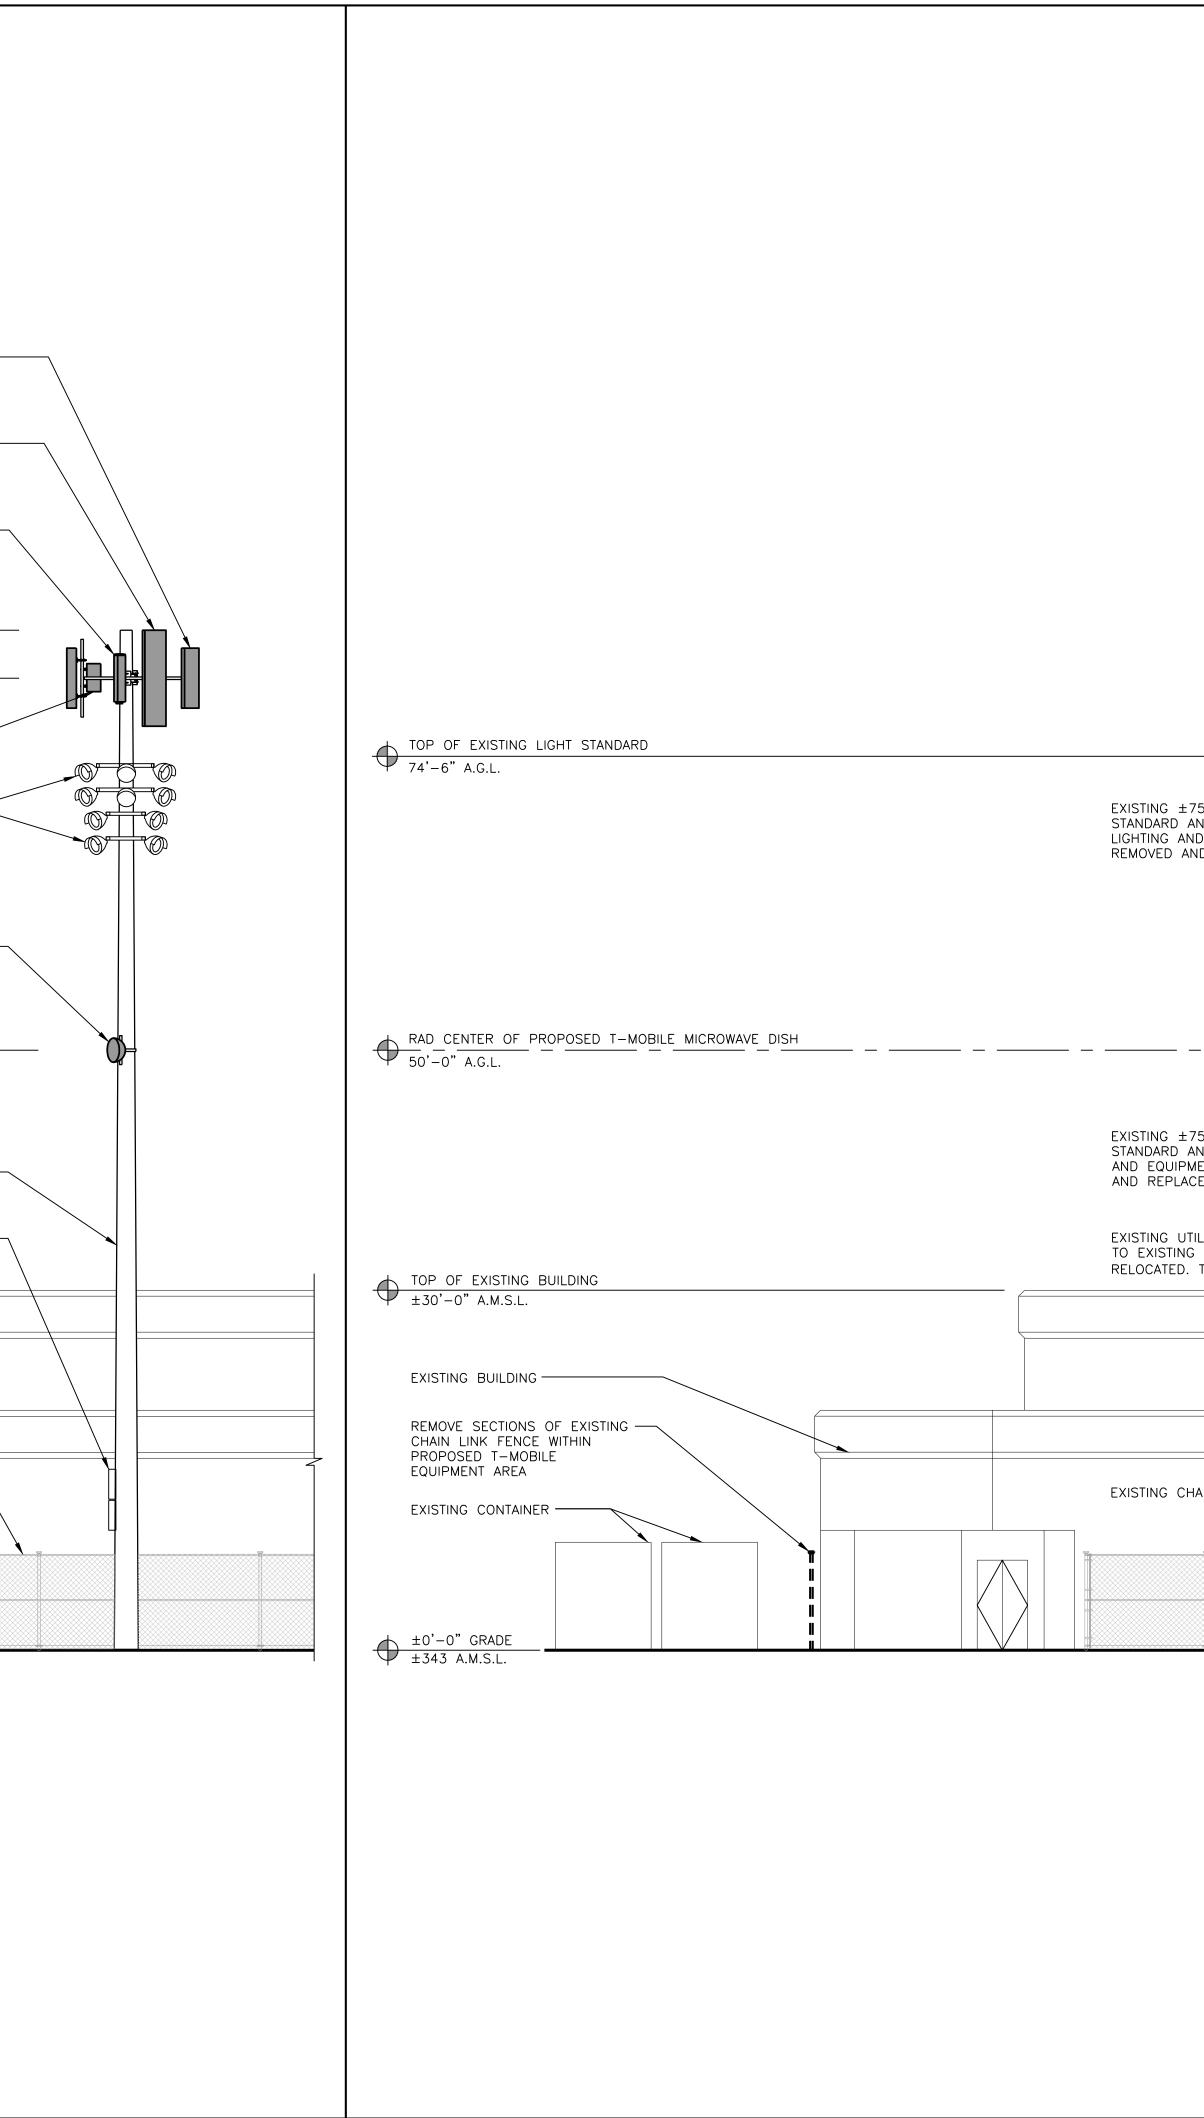

	SCALE:	2	EVICTING CONTURE EVATION
0 4' 8'	1/8"=1'-0"		EXISTING SOUTH ELEVATION

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75' HIGH MUSCO LIGHT		NO. DATE: DESCRIPTION: BY: 1 03/04/19 90% ZD NT
AND ASSOCIATED LIGHTING MENT TO BE REMOVED CED. TILITY BOX STACK MOUNTED S LIGHT STANDARD TO BE TYP. OF (2) SITE INFORMATION: SV13736A LA CITY CYPRESS	75' HIGH MUSCO LIGHT AND ASSOCIATED ID EQUIPMENT TO BE	
	ND ASSOCIATED LIGHTING ENT TO BE REMOVED ED. ILITY BOX STACK MOUNTED LIGHT STANDARD TO BE	SV13736A LA CITY CYPRESS
	SCALE: 0 4' 8' 1/8"=1'-0" 1	ELEVATIONS SHEET NUMBER: